

## INSTITUTE FOR ADVANCED LEARNING AND RESEARCH CONFERENCE FACILITY RENOVATIONS PROJECT NO. 885-18321-000 150 SLAYTON AVENUE DANVILLE, VIRGINIA 24540

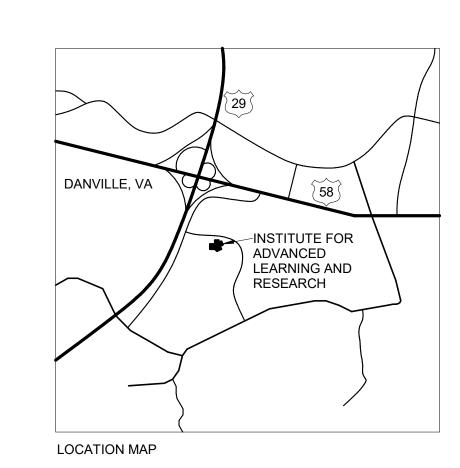

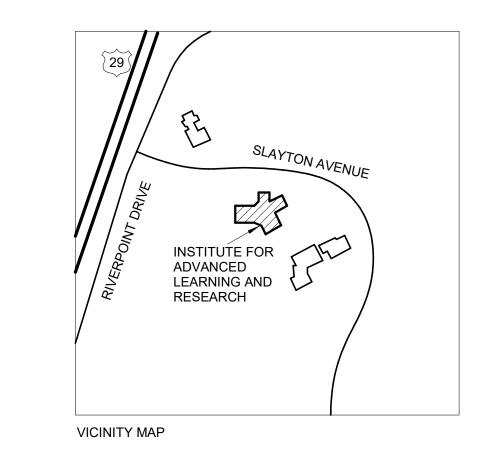

### 100% DESIGN SUBMITTAL

March 15, 2019

**Dewberry**®

551 Piney Forest Road 434.797.4497 Phone

434.797.4341 Fax

ONFI

DEB Project Code # 885-18321-000 Project No. 50100160

March 15, 2019

SUBMISSION DATE

**ARCHITECT** 

**OWNER** 

ADDRESS:

TEL NO:

150 SLAYTON AVENUE, DANVILLE, VA 24540

434.766.6730

DEWBERRY ENGINEERS, INC. (DANVILLE)

551 PINEY FOREST ROAD DANVILLE, VA 24540

TEL: 434.797.4497

FAX: 434.797.4341

LARRY W. HASSON, AIA, LEED AP BD+C, DBIA

ROBIN.BARKER@IALR.ORG CONTACT: ROBIN BARKER, GRANT & CONTRACT MANAGER

INSTITUTE FOR ADVANCED LEARNING AND RESEARCH


**ENGINEERS** 

PROJECT INFORMATION

DEWBERRY ENGINEERS, INC. (RALEIGH) 2610 WYCLIFF ROAD, SUITE 410

RALEIGH, NC 27607 TEL: 919.881.9939

FAX: 919.851.9923 ELECTRICAL: WILLIAM A. KEMP, P.E.

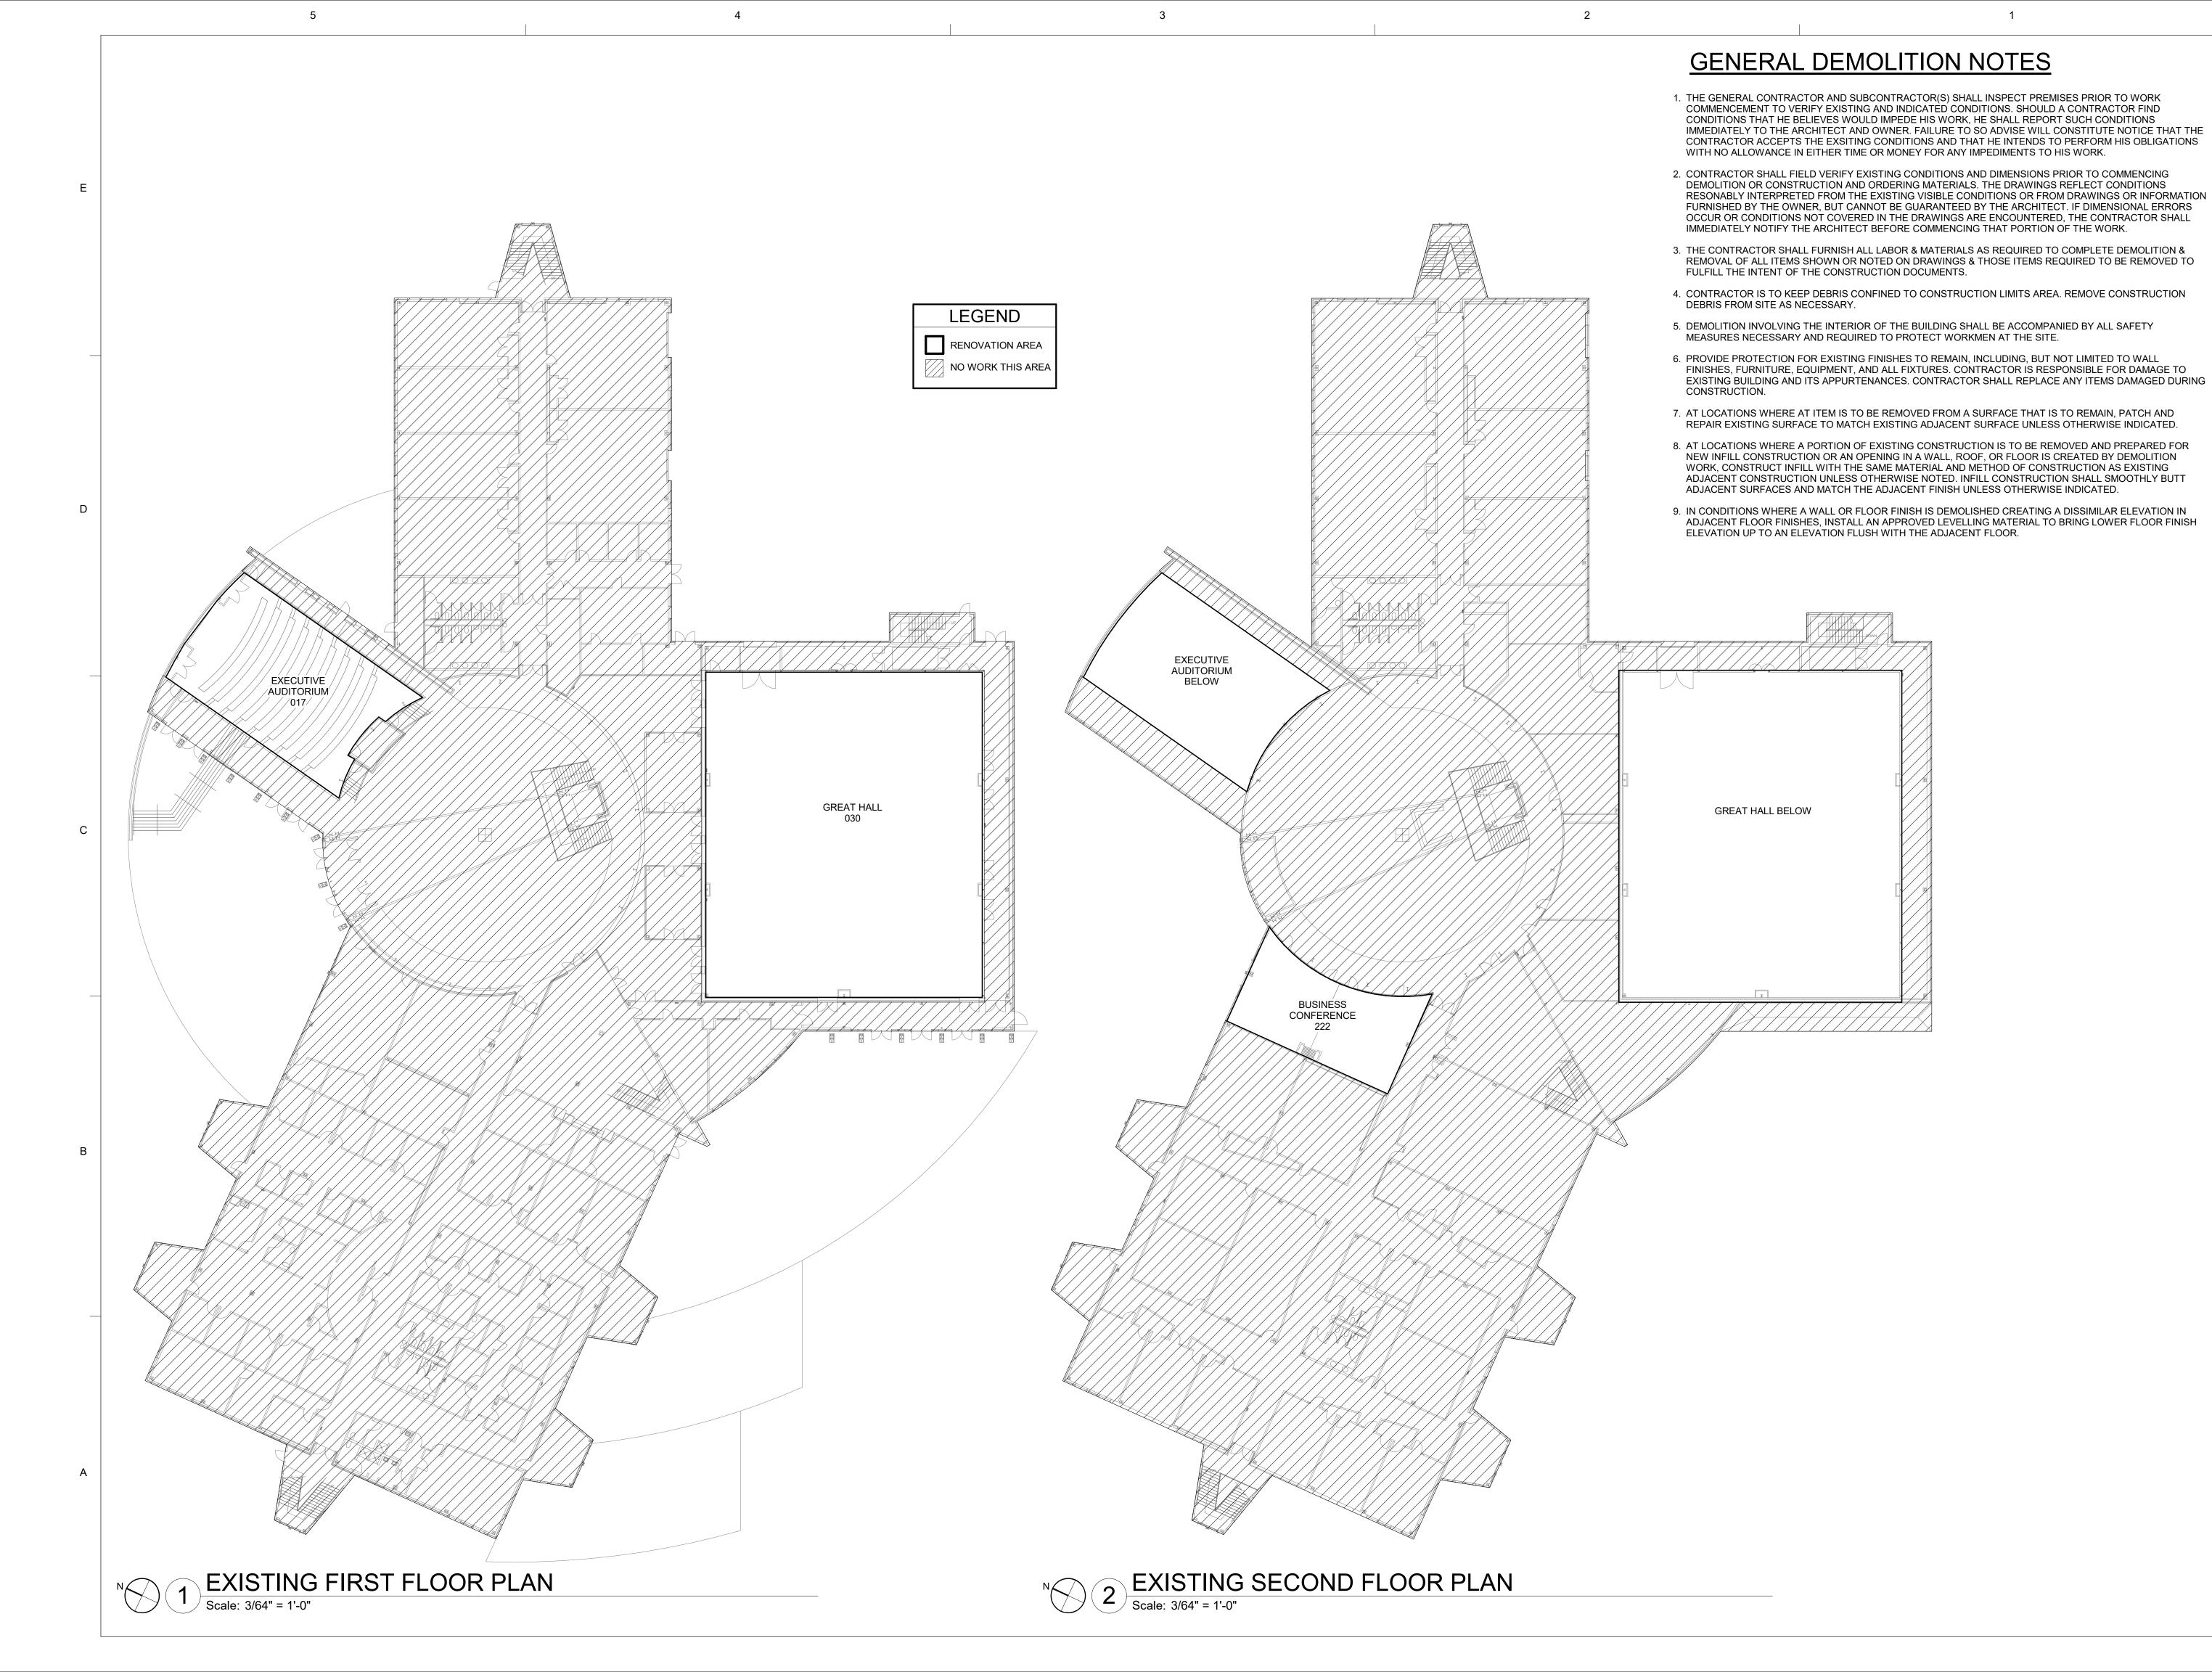




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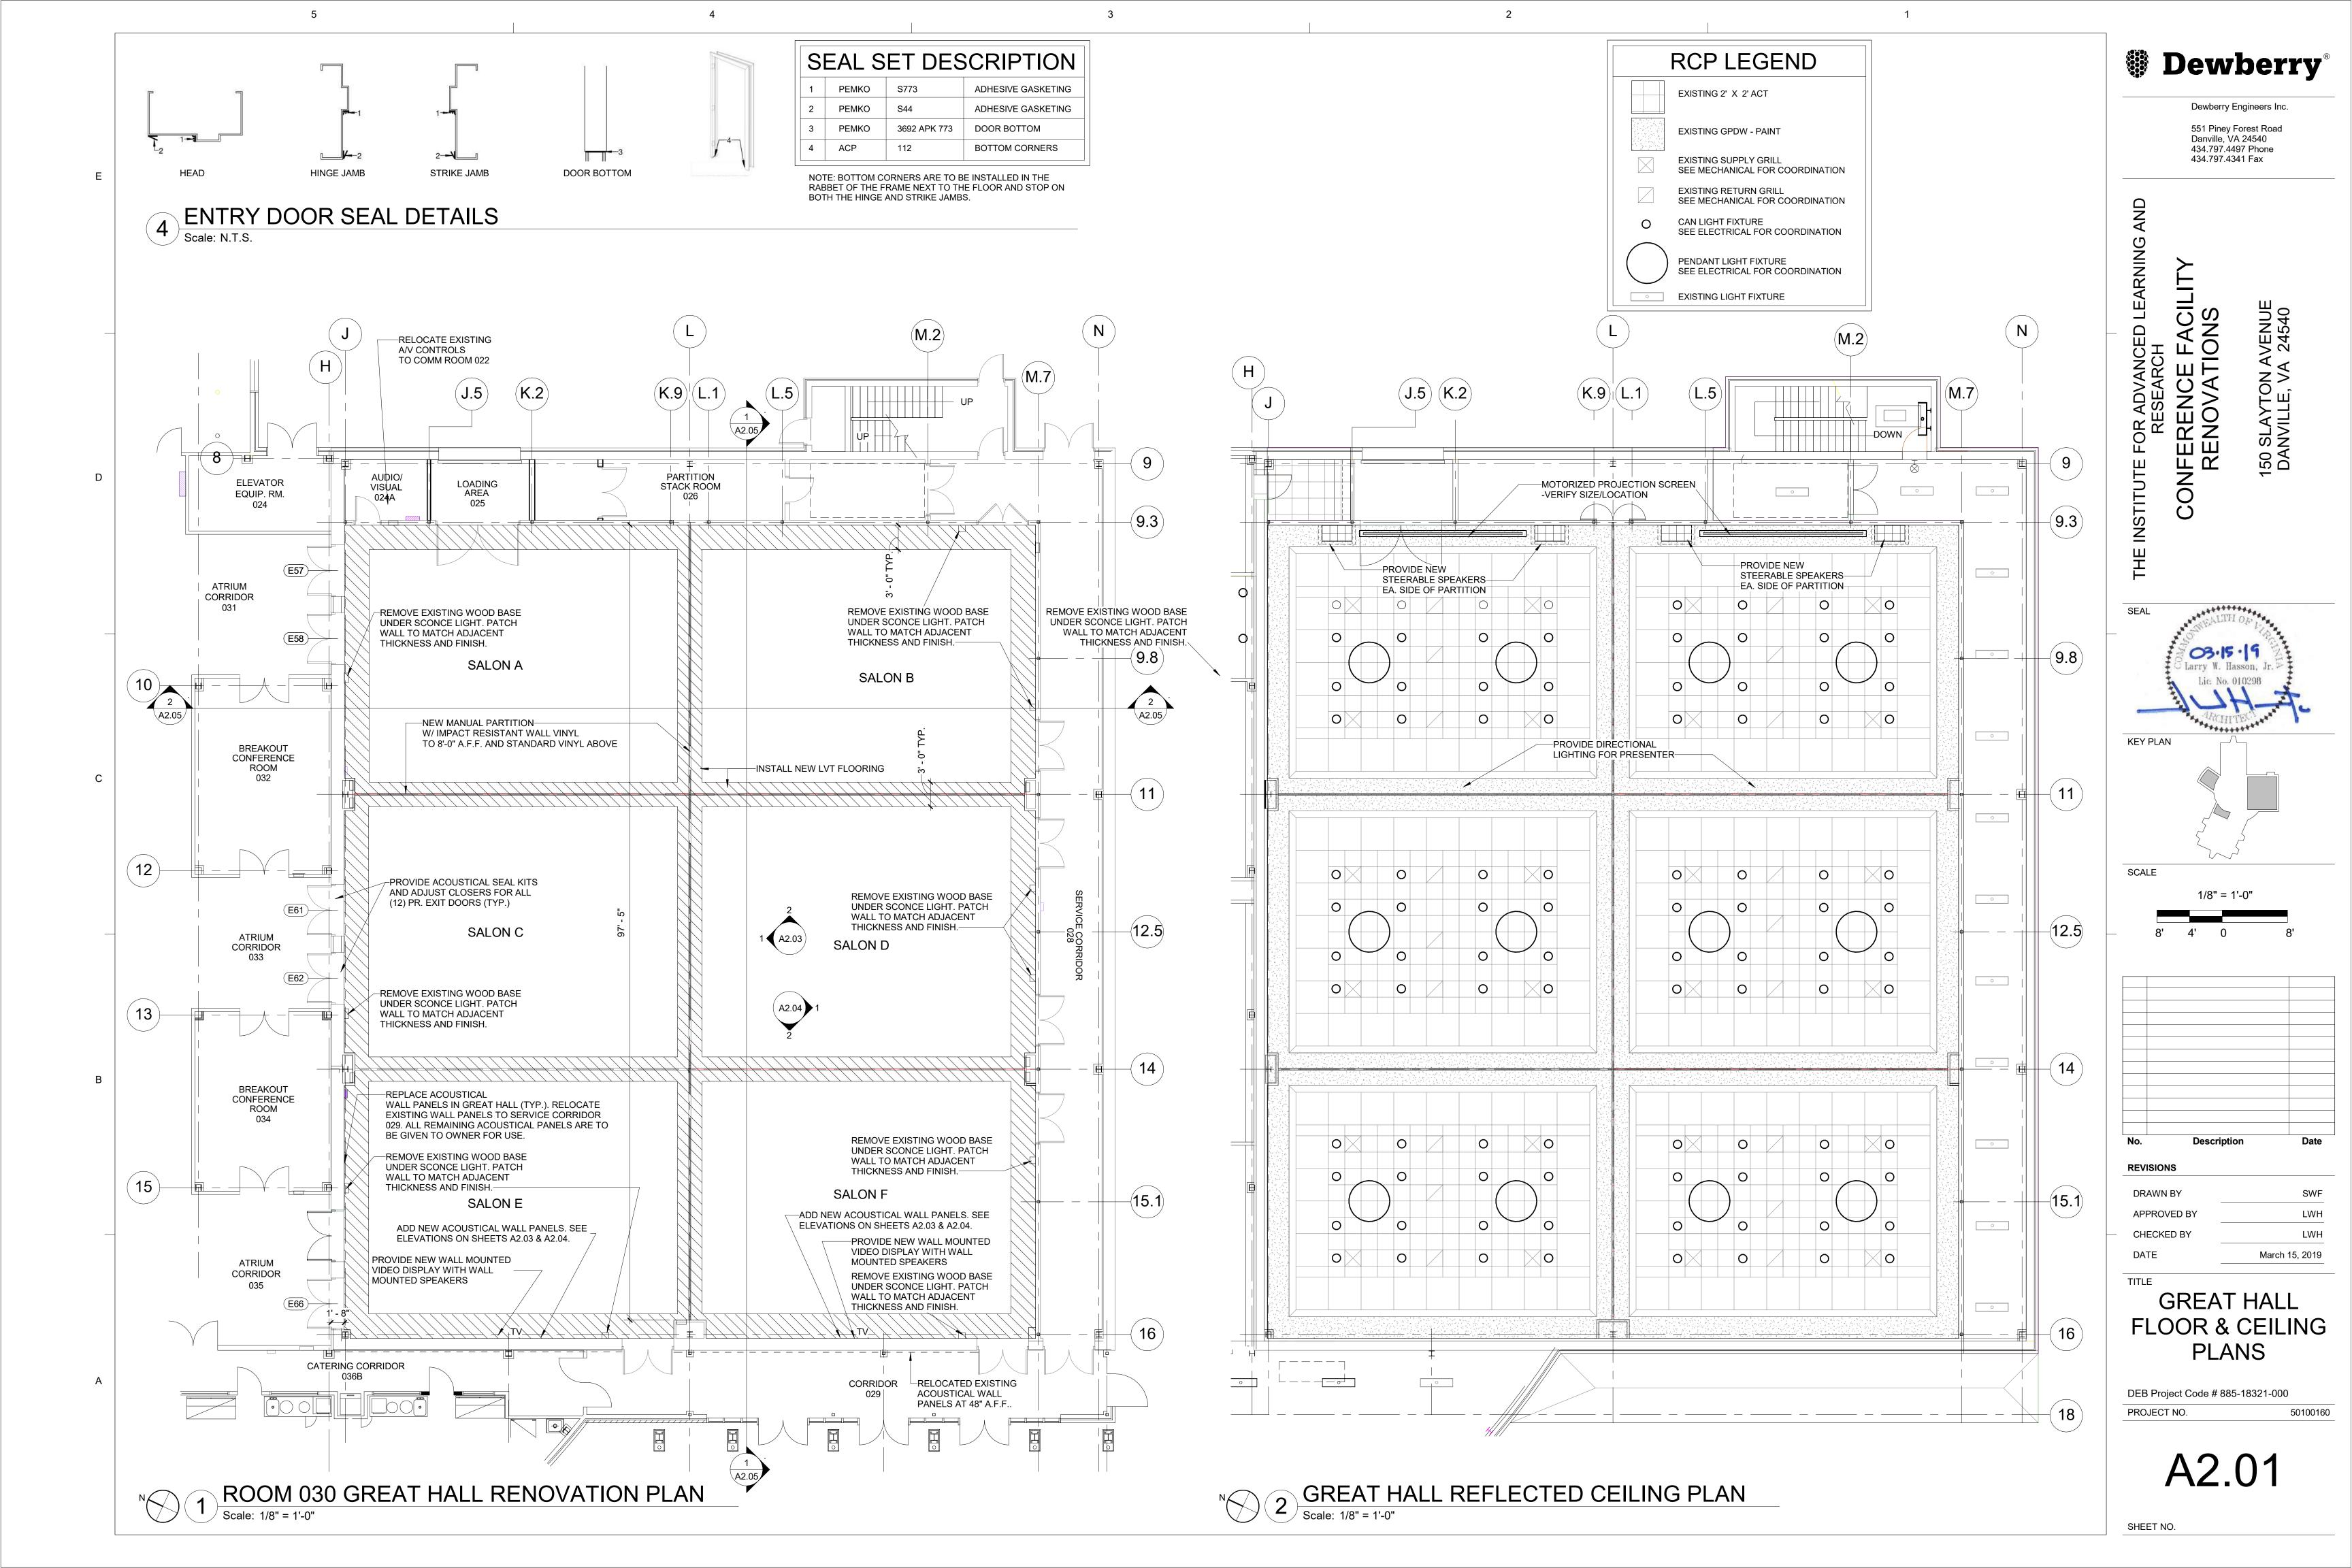
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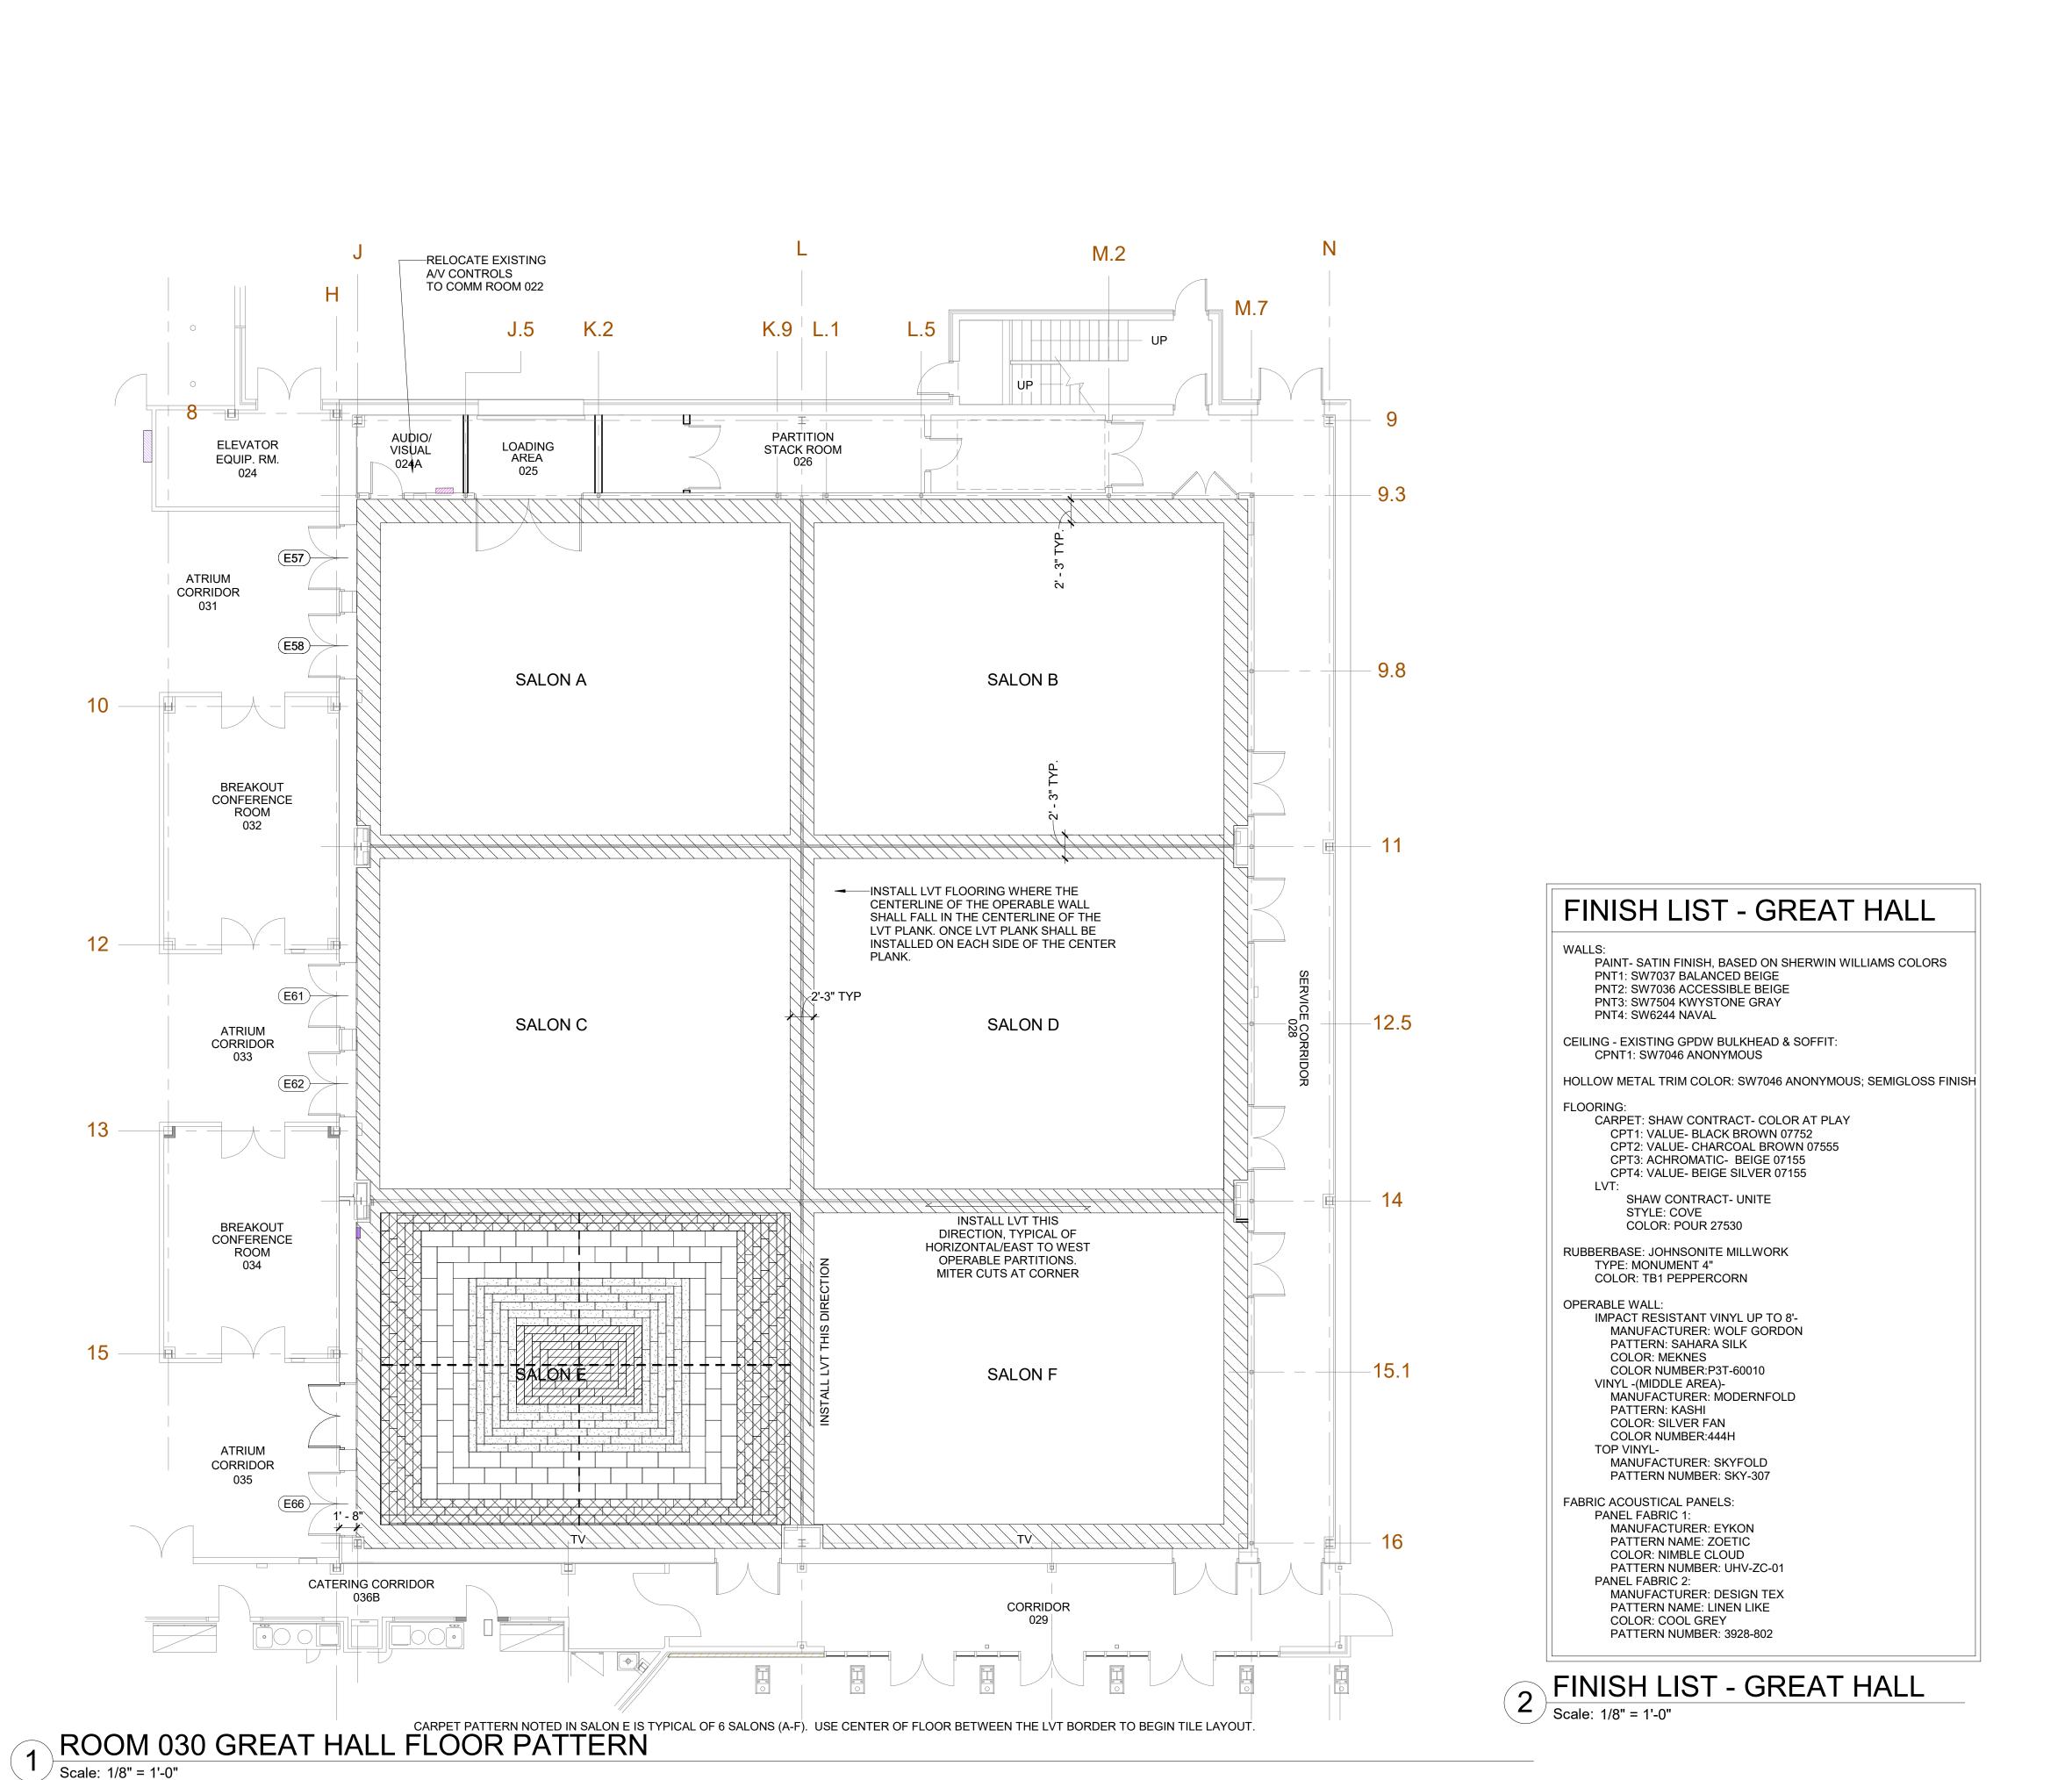


BUILDING FLOOR PLANS

DEB Project Code # 885-18321-000
PROJECT NO. 50

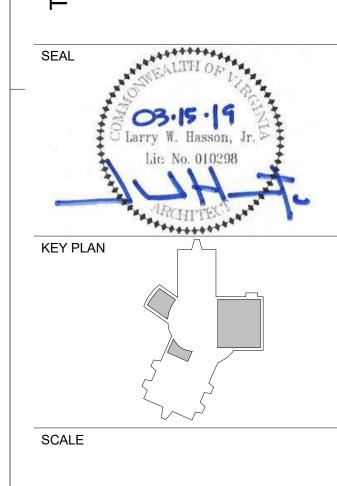A1.01







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RENOVATIONS



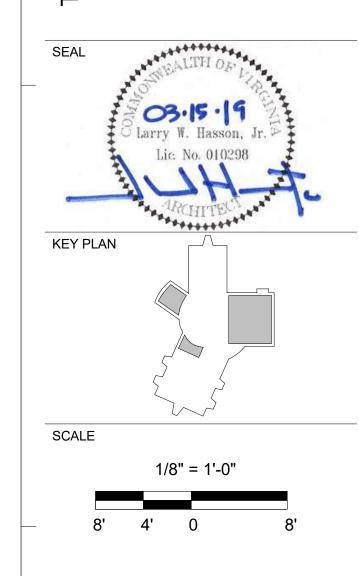



GREAT HALL
FLOOR PATTERN
PLAN AND FINISH
LIST

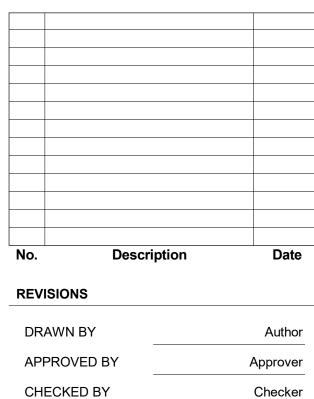March 15, 2019

DEB Project Code # 885-18321-000
PROJECT NO. 50100160

A2.02

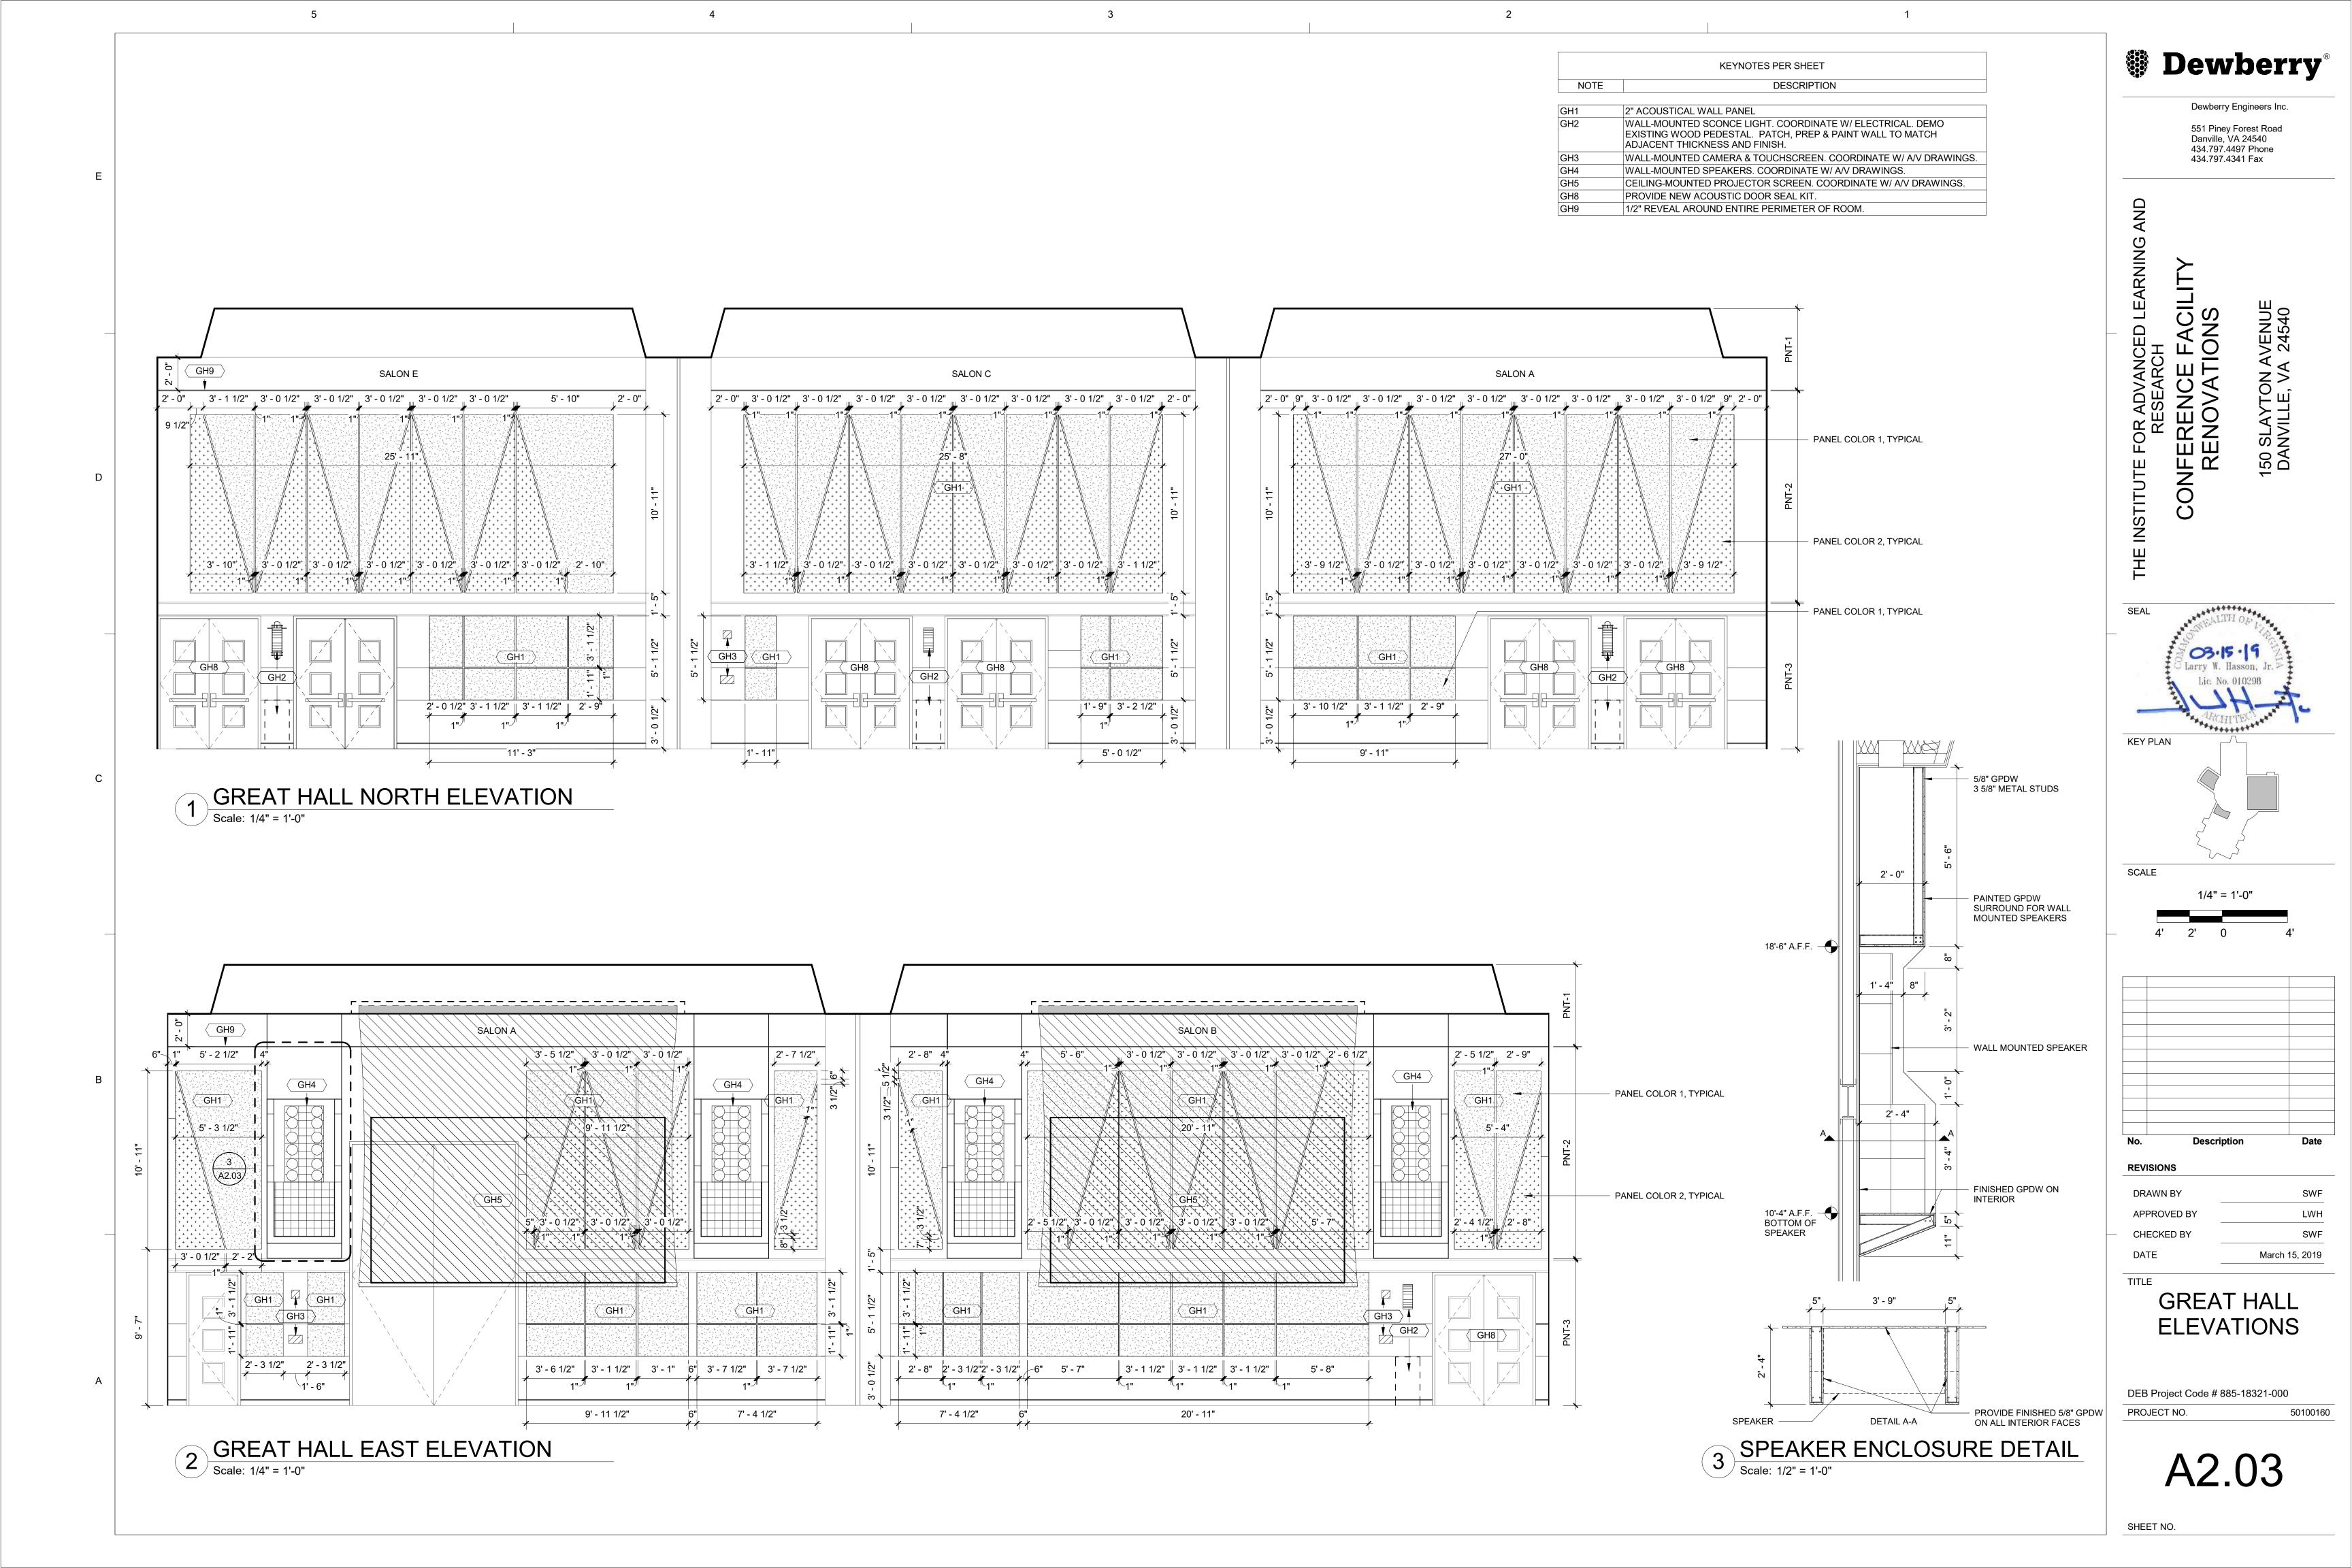

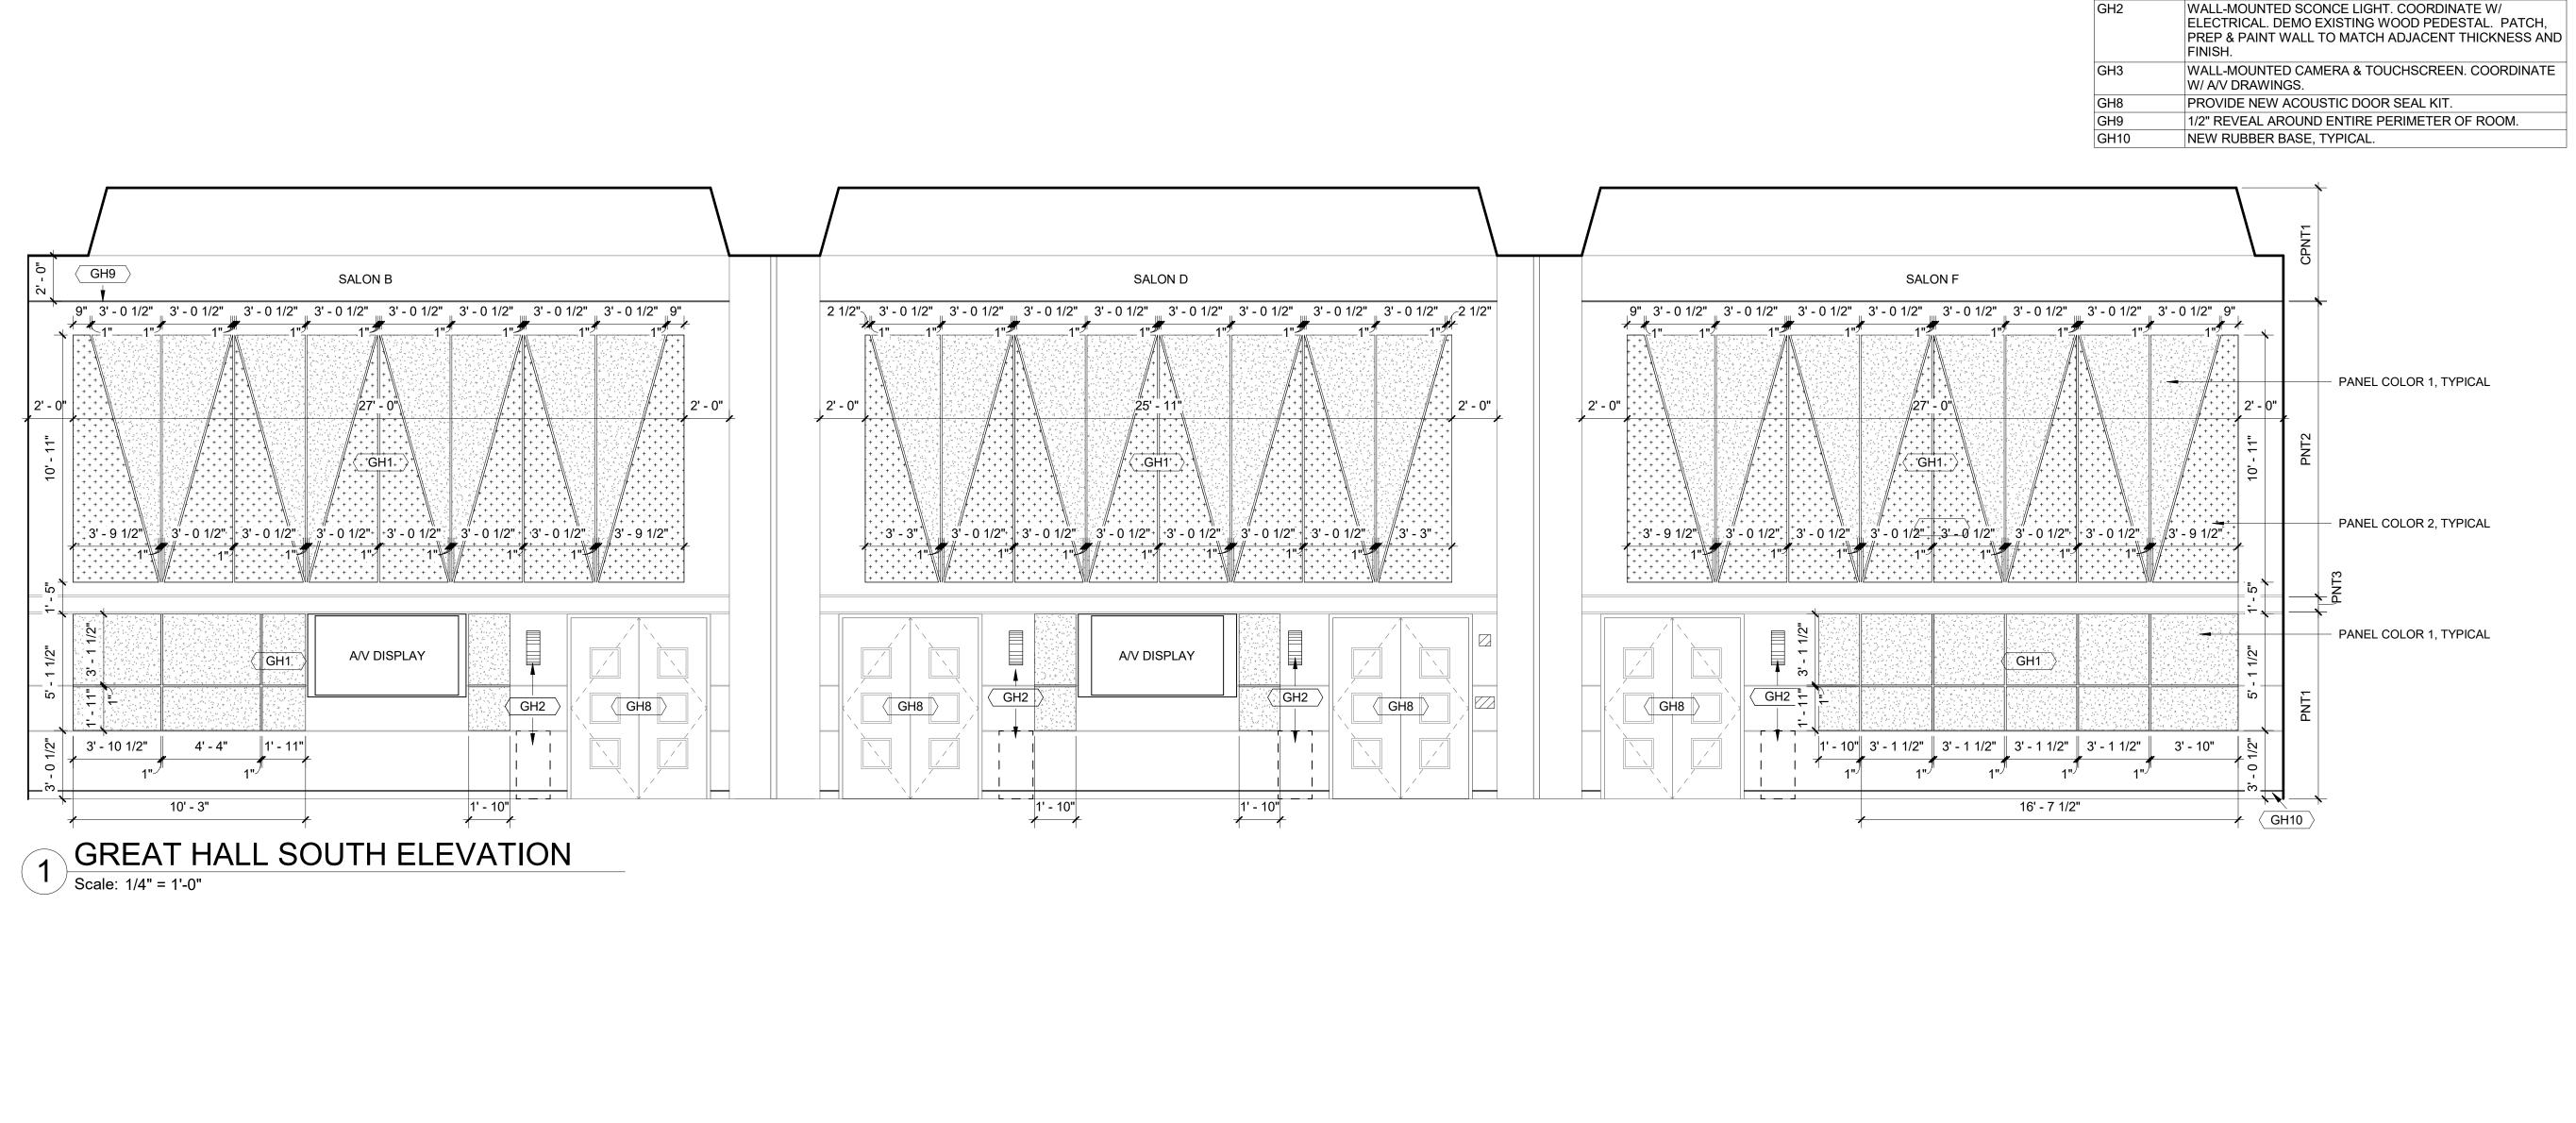

SALON E

2' - 0" | 2' - 4" | 3' - 0 1/2" | 3' - 0 1/2" 
36' - 4"

GH1

| - 1 | - 2 | - 4 | - 3 | - 0 | 1/2 | - 3 | - 0 | 1/2 | - 3 | - 0

A/V DISPLAY

9' - 6"

GH3

2' - 2 1/2" 3' - 1 1/2" 3' - 1 1/2" 1' - 11" 5 1" 1" 1" 1" 0

10' - 7 1/2"

GH3

3' - 1 1/2" | 3' - 1 1/2" | 1' - 0"

8' - 10"



KEYNOTES PER SHEET

2" ACOUSTICAL WALL PANEL

DESCRIPTION

NOTE

- PANEL COLOR 1, TYPICAL

PANEL COLOR 2, TYPICAL

PANEL COLOR 1, TYPICAL


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표

SEAL 03.15.1 KEY PLAN SCALE



**ELEVATIONS** 

DEB Project Code # 885-18321-000 PROJECT NO.

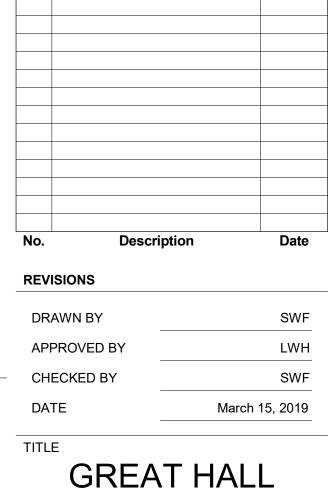SHEET NO.

10' - 5 1/2" GREAT HALL WEST ELEVATION

Scale: 1/4" = 1'-0"

SALON F

+ GH1

GH3

GH1

1' - 9 1/2" 3' - 0 1/2" | 3' - 0 1/2" | 3' -

35' - 6 1/2"

1' - 9 1/2" 3' - 0 1/2" # 3' -

A/V DISPLAY

9' - 8"

9' - 8"

GH1


| 3' - 1 1/2" | 3' - 1 1/2" | 1' - 8" | 5

8' - 1"

GH8

GH9


GH8

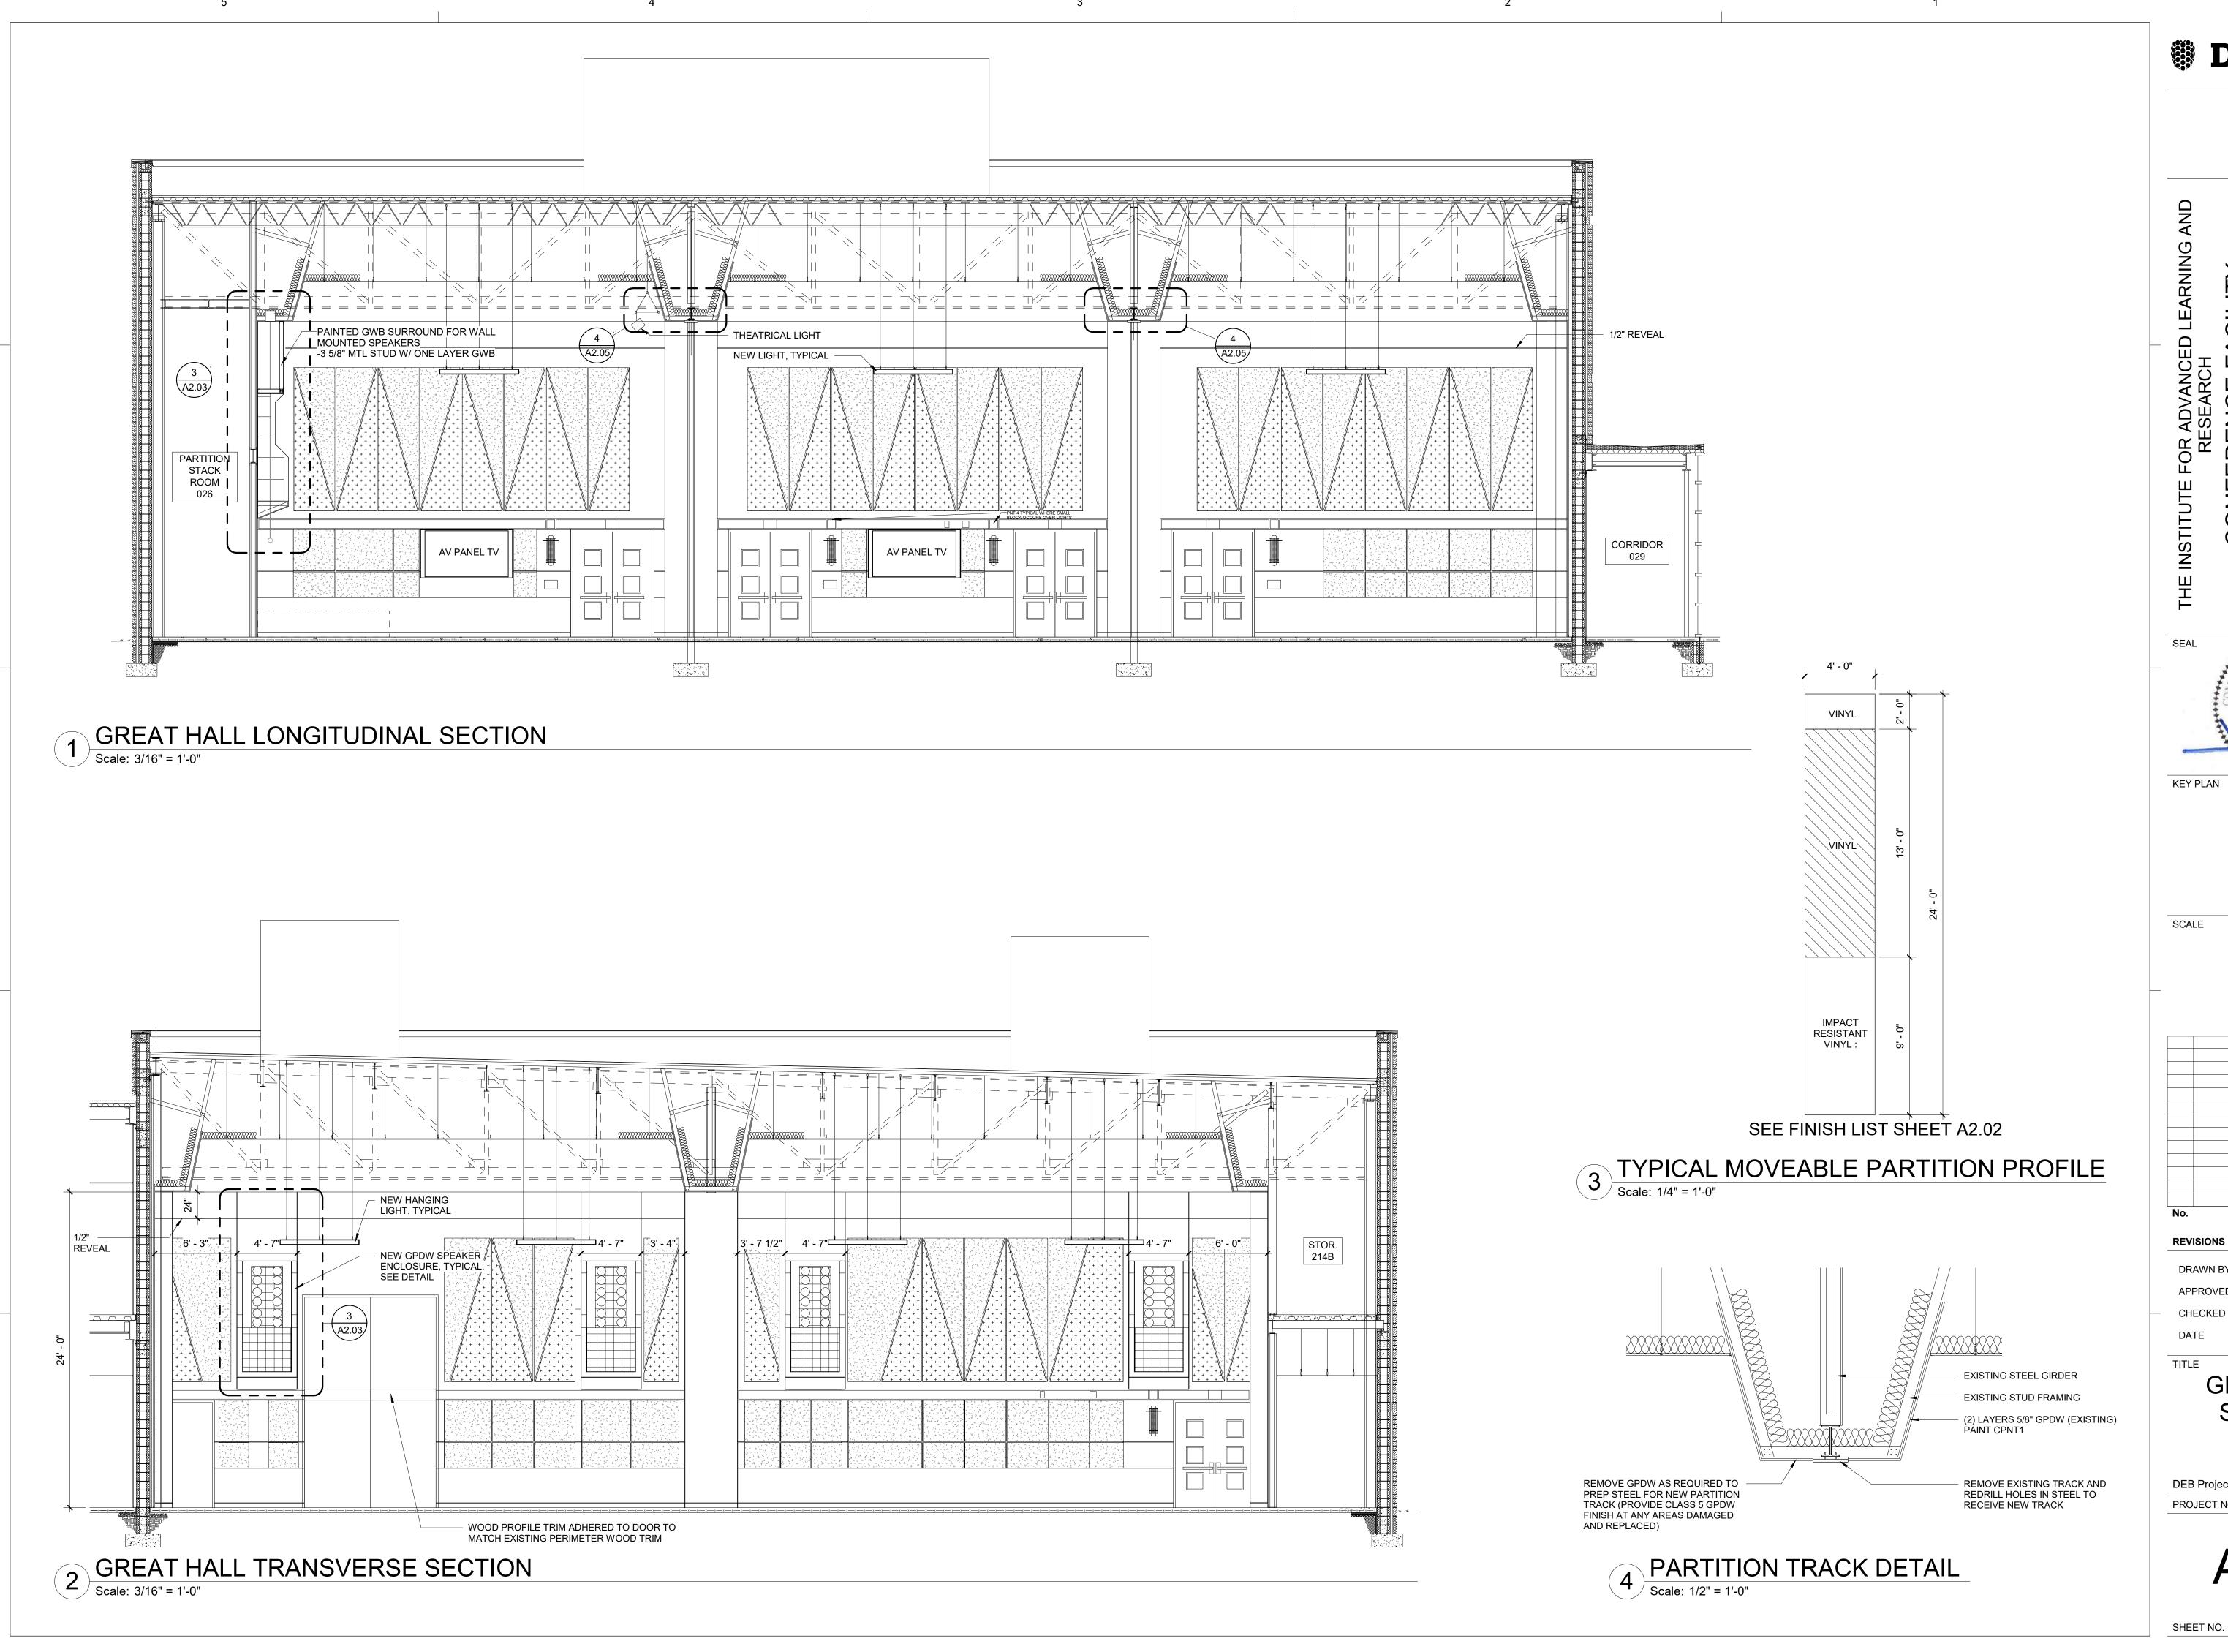

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03.15. KEY PLAN As indicated




**GREAT HALL** SECTIONS

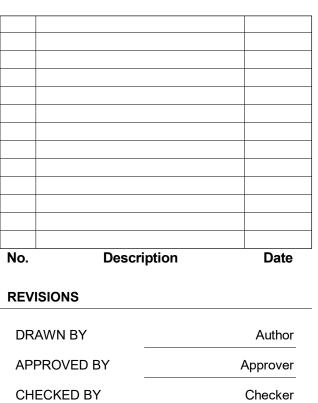
March 15, 2019

DEB Project Code # 885-18321-000 PROJECT NO. 50100160

A2.05

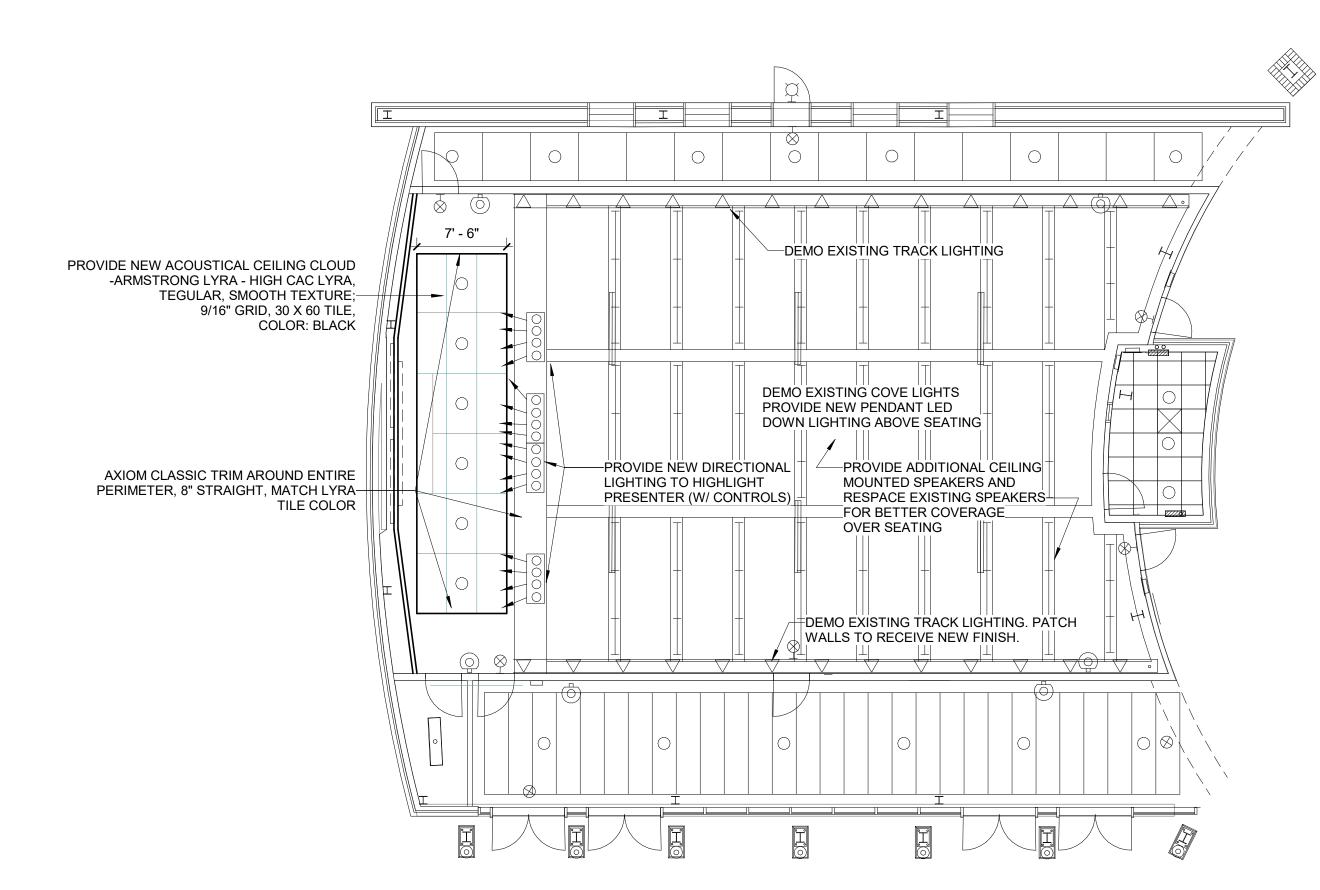

## 2 EXECUTIVE AUDITORIUM - REFLECTED CEILING PLAN Scale: 1/8" = 1'-0"

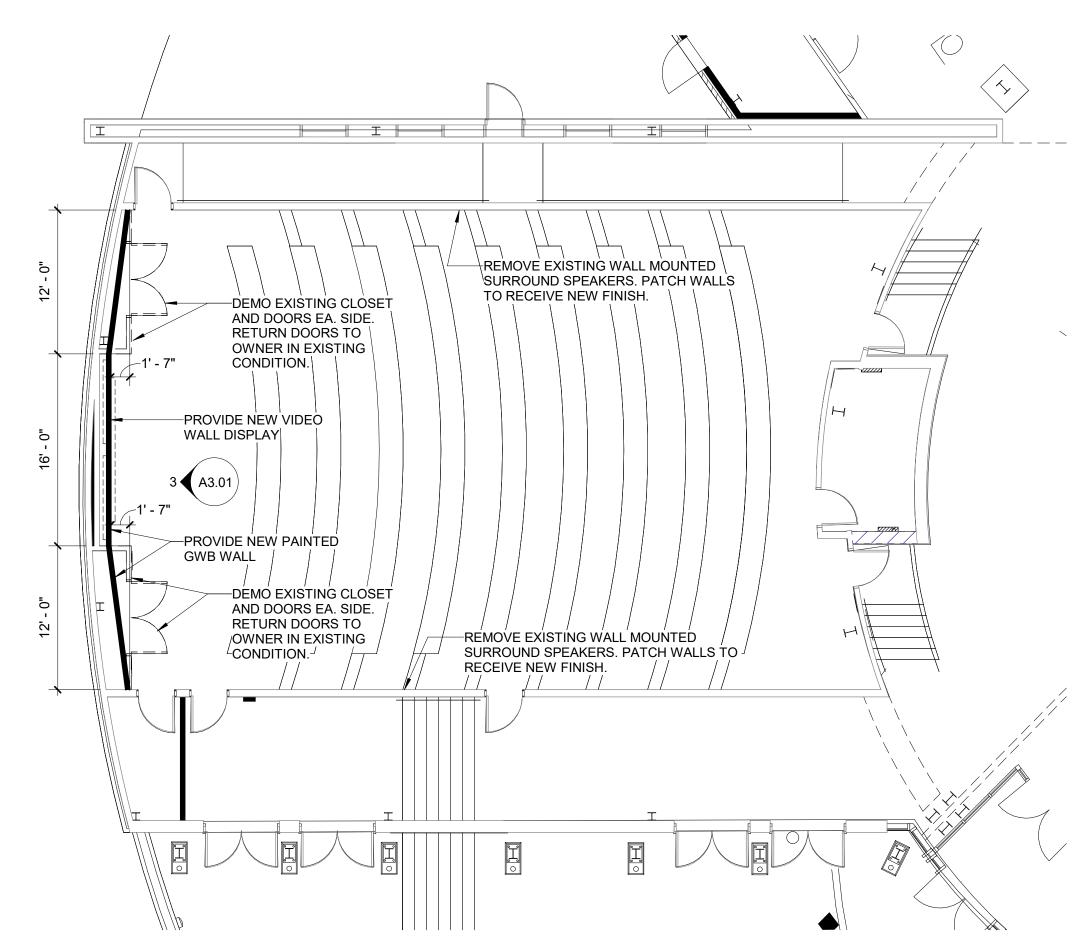

EXECUTIVE AUDITORIUM PLAN

Scale: 1/8" = 1'-0"

# THE INSTITUTE SEAL 03.15.1 KEY PLAN SCALE

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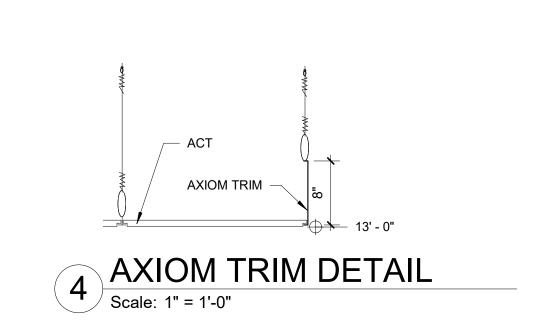
EXECUTIVE AUDITORIUM RENOVATION PLANS
DEB Project Code # 885-18321-000

50100160

A3.01

SHEET NO.


PROJECT NO.



EXISTING SPEAKER COVER TO BE RELOCATED ONCE NEW WALLS ARE IN PLACE		NEW VIDEO WALL DISPLAY 1/2" X 1/2" REVEALS IN EXISTING SPEAKER (COORDINATE W/ AV DRAWINGS) NEW GPDW WALL
	2'-0"	
	2'-4"	
	2'-4"	
	.2 - 4"	
	28"	PNT1- TYPICAL OF WALL
	2' - 6 1/2"	4" RUBBER BASE

3 EXECUTIVE AUDITORIUM - ELEVATION

Scale: 1/4" = 1'-0"

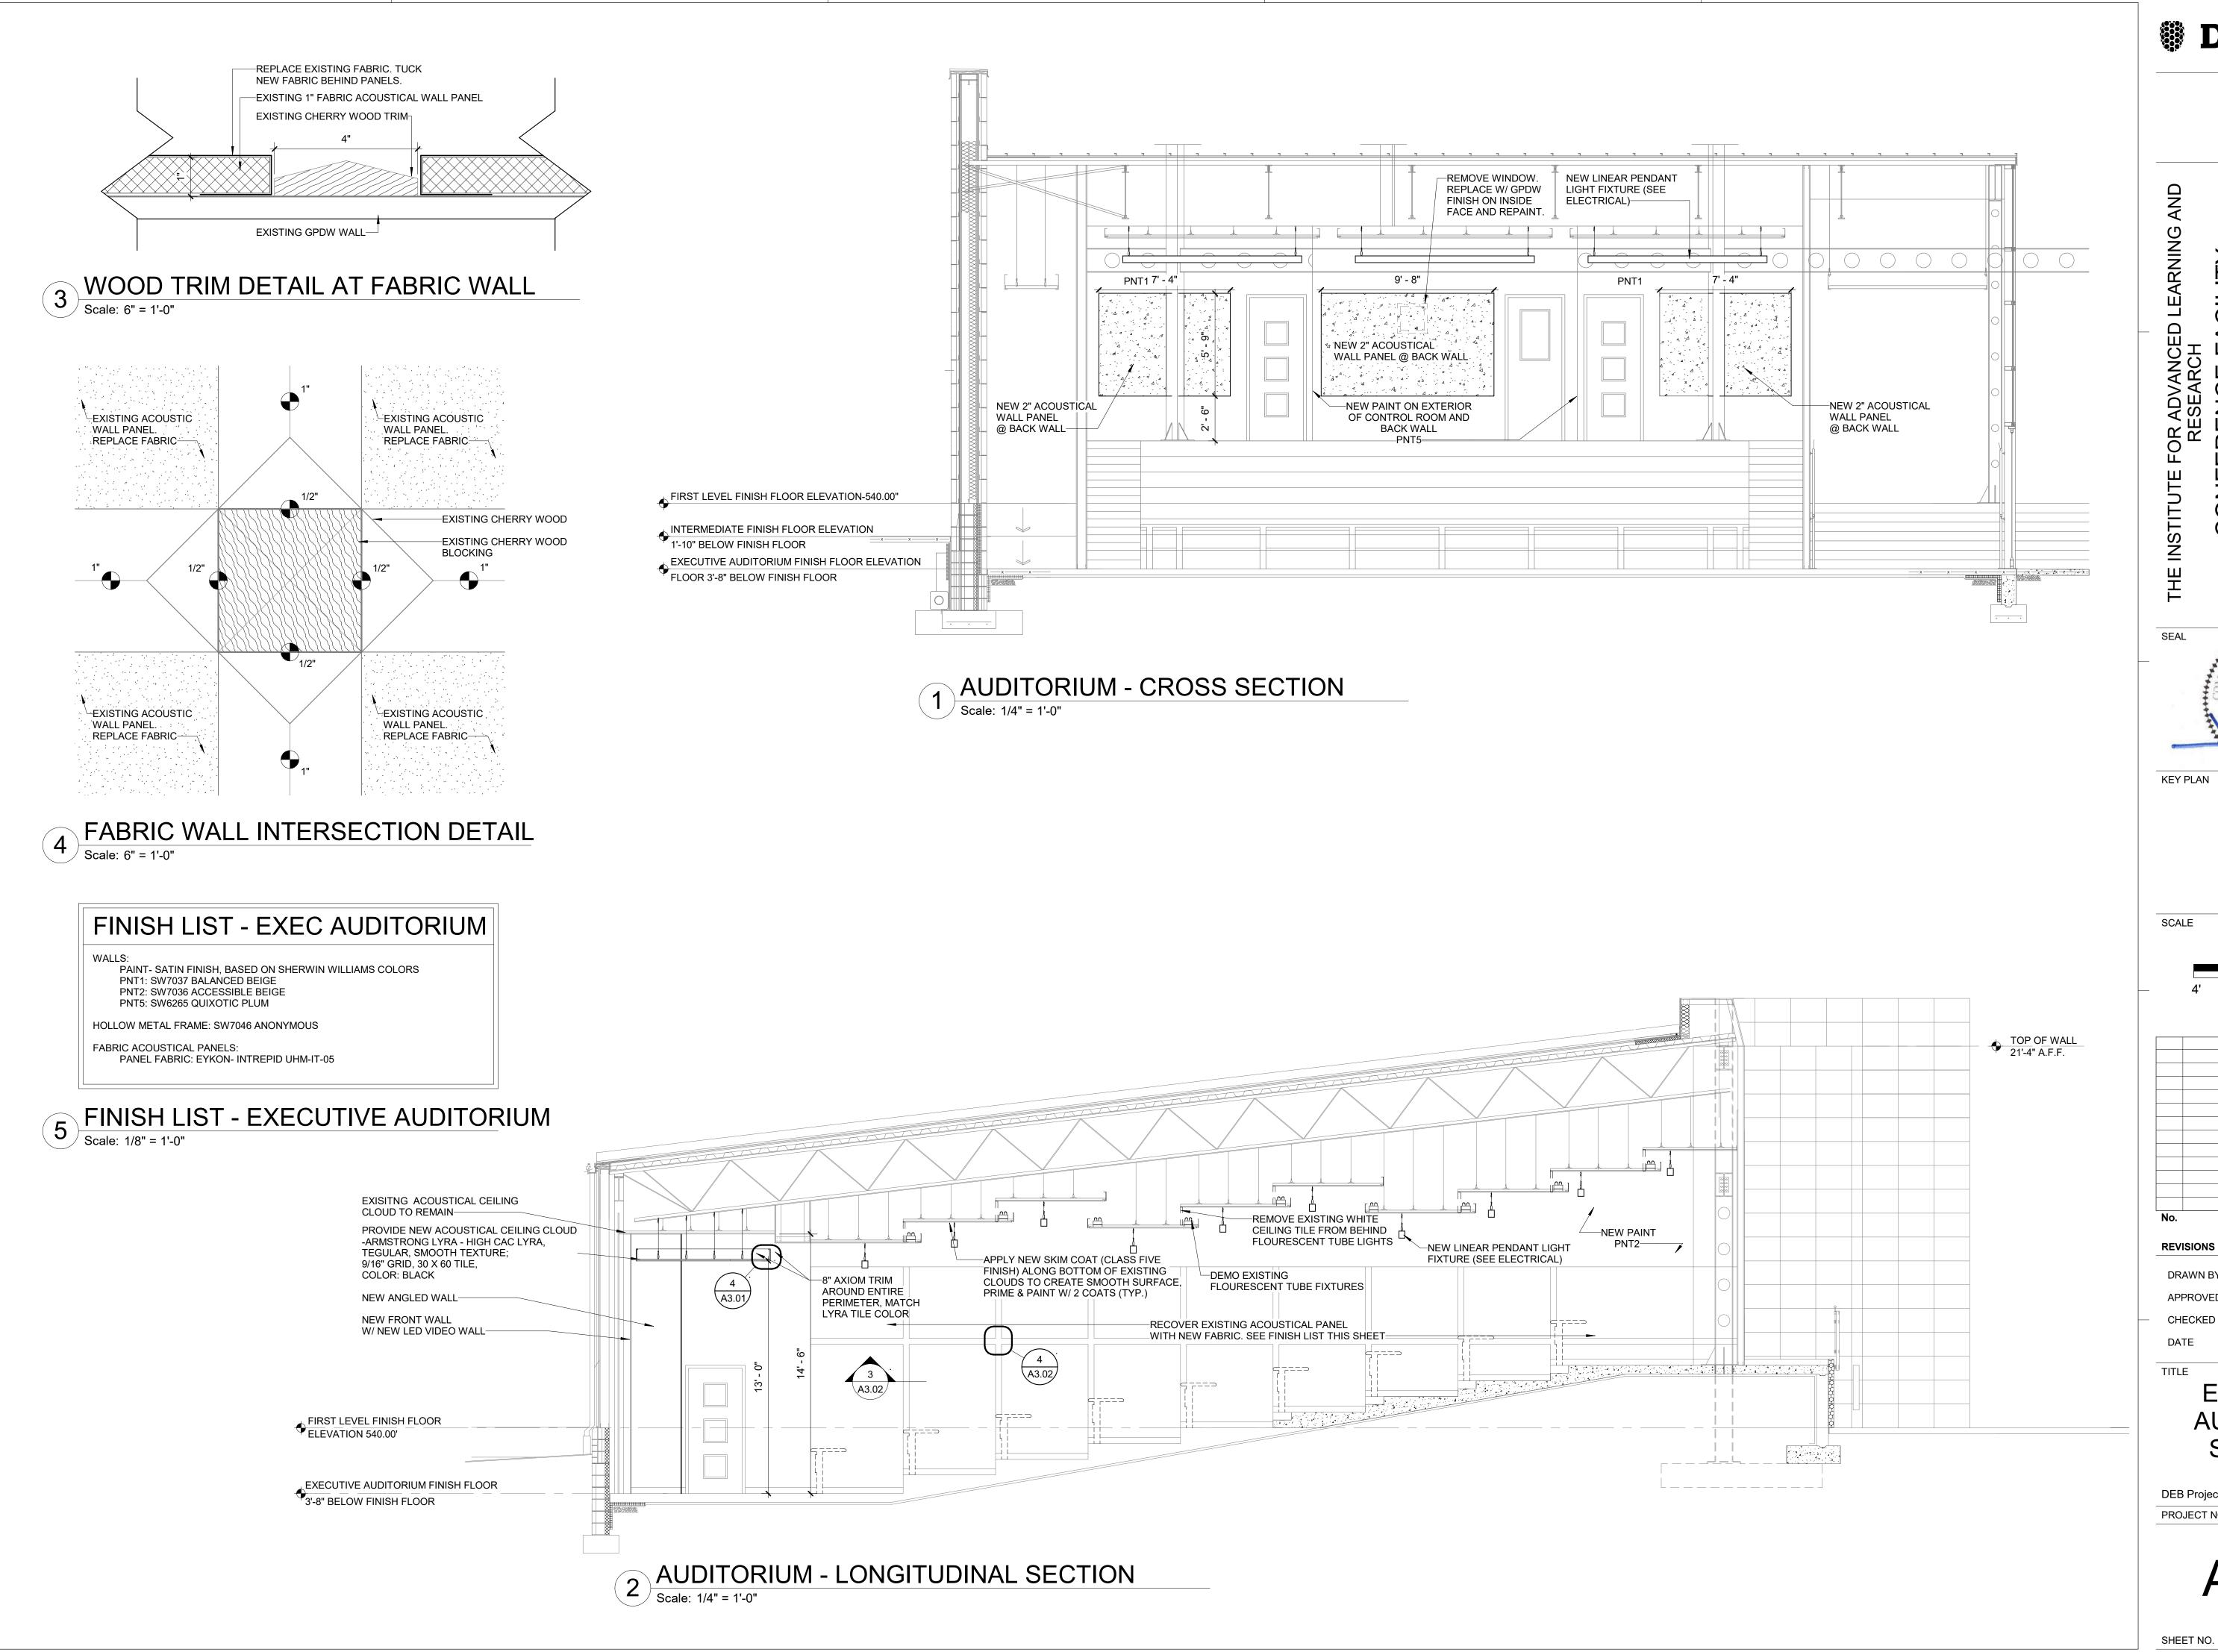

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NFERENCE FACILITY RENOVATIONS

150 SLAYTON AV

SEAL

SEAL

SEAL

SEAL

SEAL

SEAL

SCALE

No. Description Date

REVISIONS

DRAWN BY ANS

APPROVED BY LWH


CHECKED BY SWF

DATE March 15, 2019

EXECUTIVE AUDITORIUM SECTIONS

DEB Project Code # 885-18321-000
PROJECT NO. 50100160

A3.02

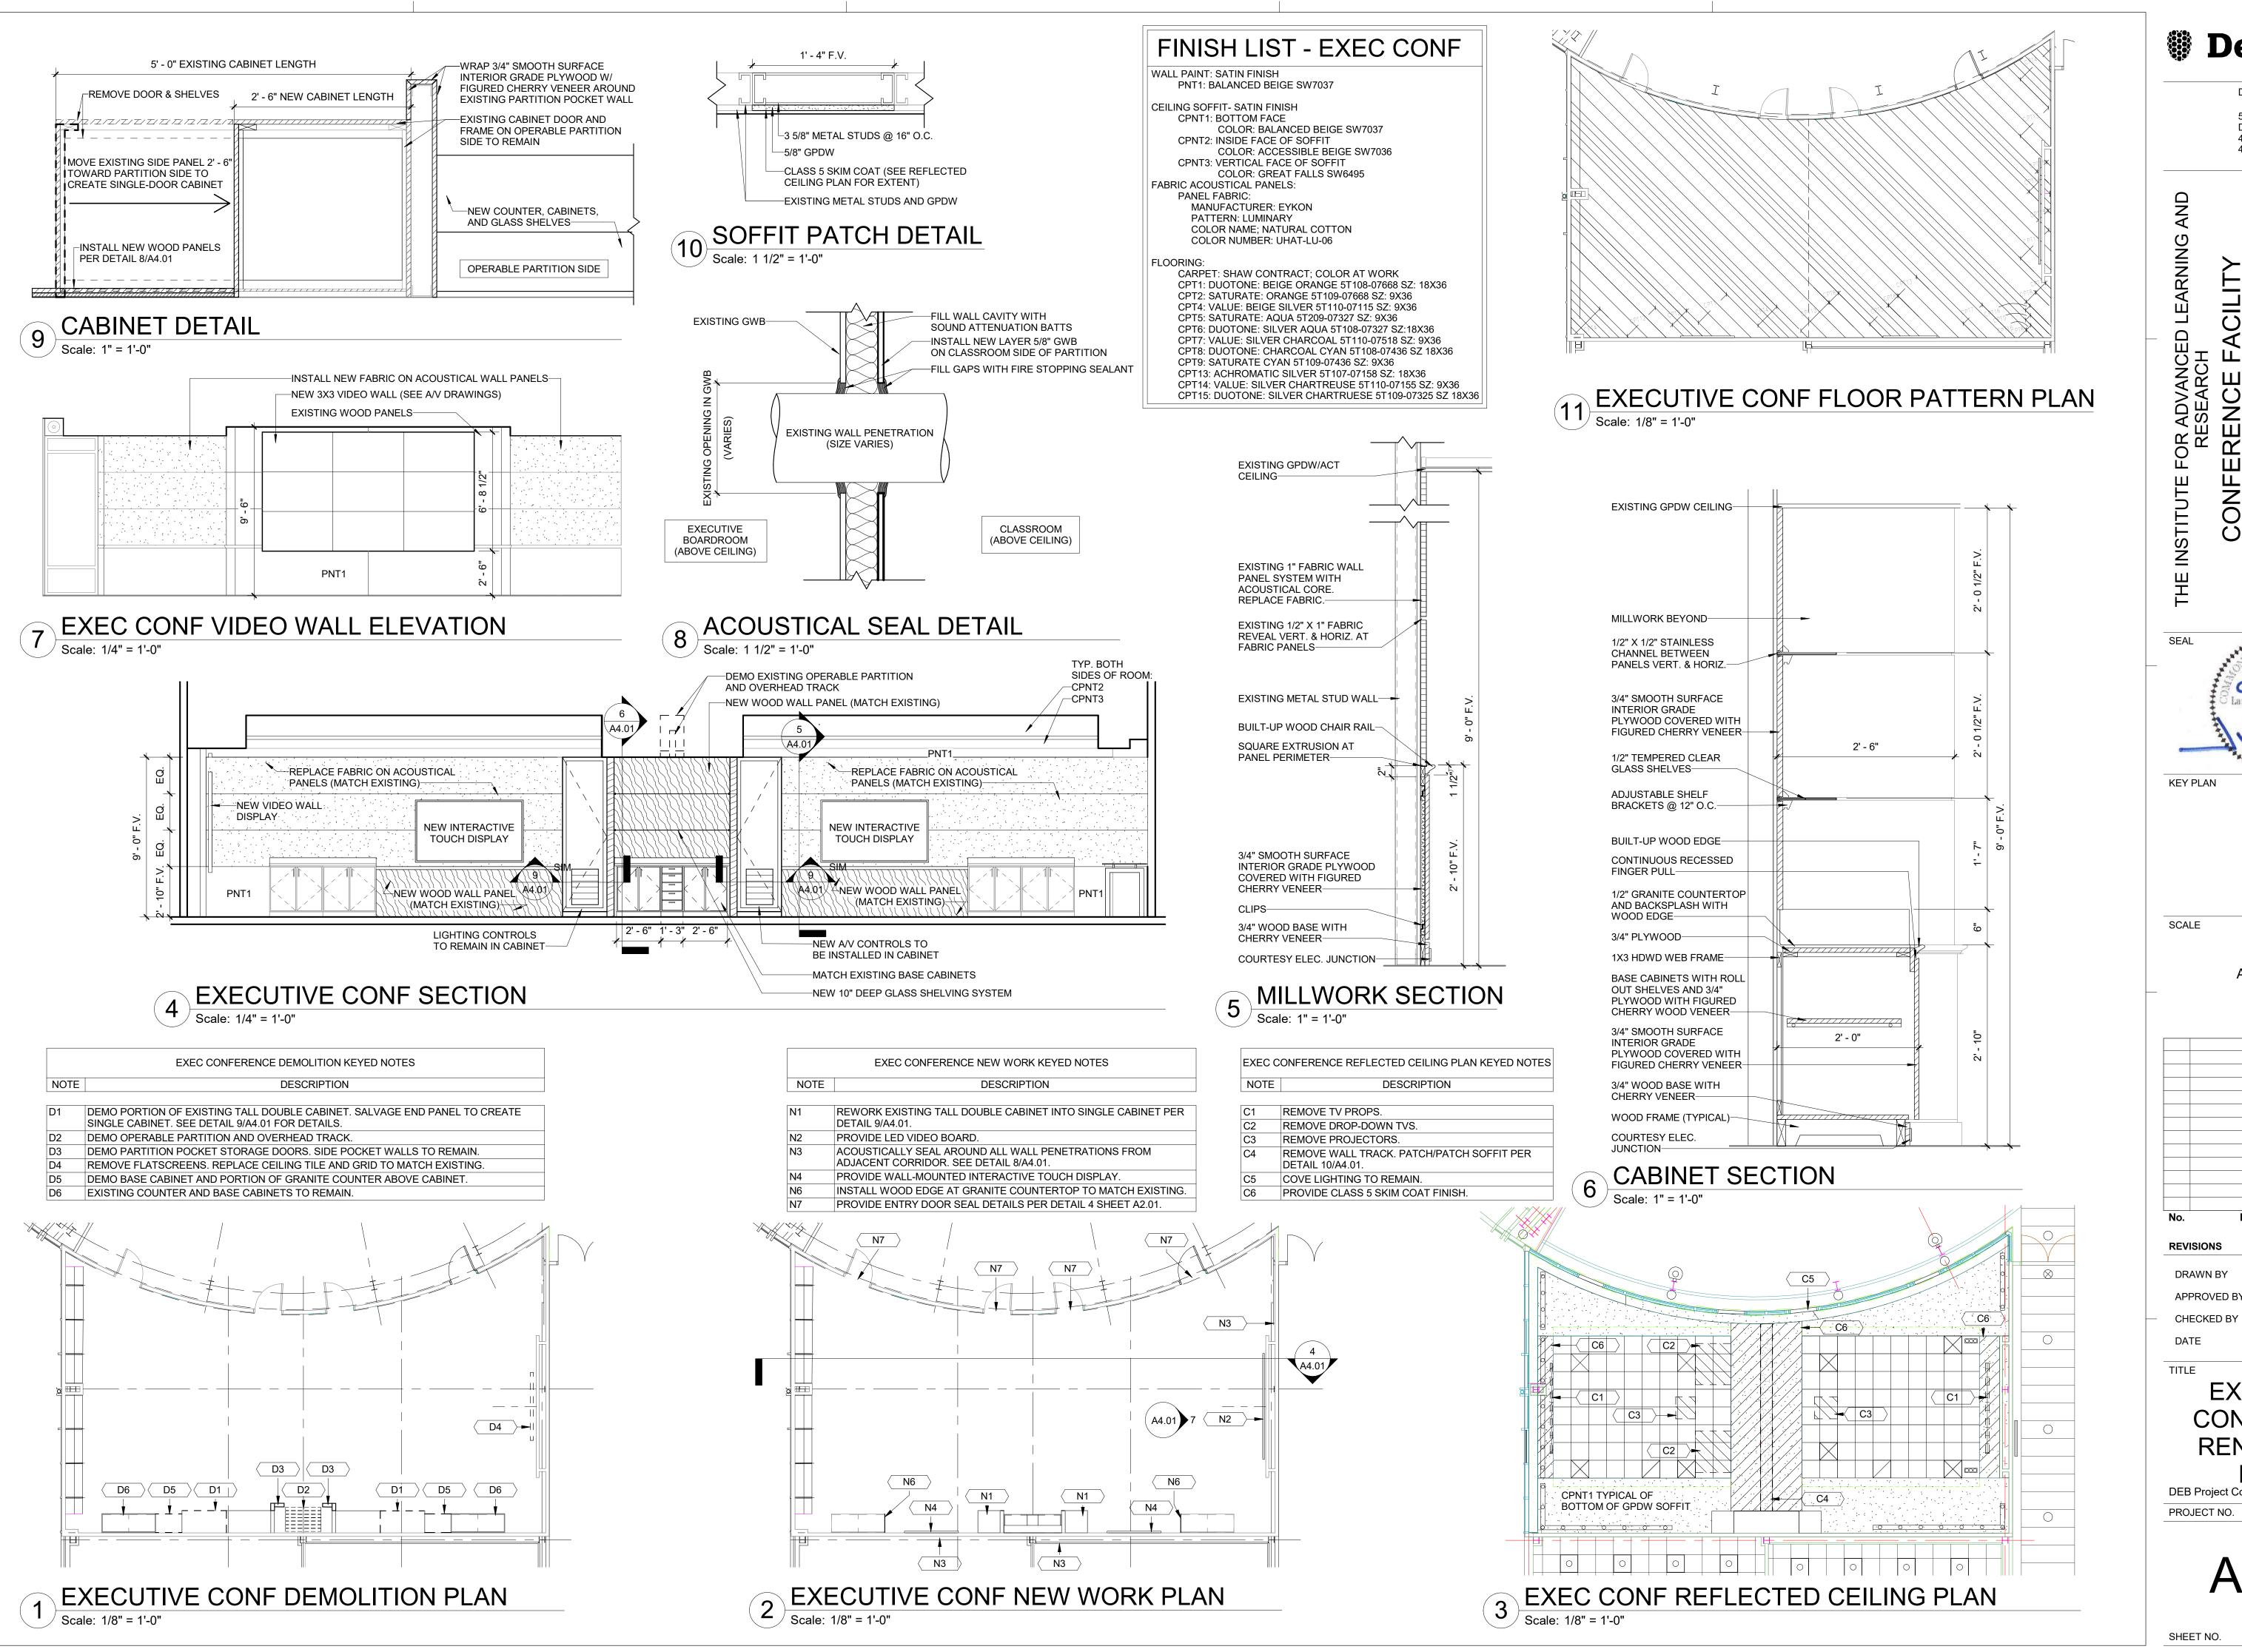

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KEY PLAN

As indicated

Description **REVISIONS** DRAWN BY

> March 15, 2019 EXECUTIVE CONFERENCE

SWF

RENOVATION **PLANS** DEB Project Code # 885-18321-000

50100160

A4.01

GOTHAM ICO #35/30-6AR-LSS-EZ1

OCL #FX1-S1SA-18-MW-BAL-LED-120-DML

SCD-M-48-30-MULT; LDCM-PL-120-277-010V-GR

OR APPROVED EQUAL

OR APPROVED EQUAL

OR APPROVED EQUAL

INTEGRAL LED, 3500K, 80 CRI

INTEGRAL LED, 3500K, 80 CRI

3000 DELIVERED LUMENS, 115 LPW

800 DELIVERED LUMENS, 115 LPW

470 LM/FT (1880 DELIVERED LUMENS)

N/A

N/A

120/277

120

120-277

22" WIDE

10 7/8" HIGH

7" WIDE

18: HIGH

4" DEEP

1.2" HIGH

48" LONG

4. VERIFY FIXTURE CONTROL WIRING REQUIREMENTS PRIOR TO ORDERING FIXTURES TO INSURE EXISTING CONTROL WIRING IS COMPATIBLE WITH 0-10V ADAPTER.

2. CONTRACTOR SHALL COORDINATE FIXTURE MOUNTING STYLE (GRID VERSUS GYP-BOARD) WITH ARCHITECTURAL REFLECTED CEILING PLANS.

3. ALL RECESSED DOWNLIGHTS WHERE INSTALLED IN ACCOUSTICAL CEILING TILE SHALL BE PROVIDED WITH 24" GRID BAR HANGERS

20 9/16" LONG RECESSED IN CEILING

WALL, SURFACE

WALL, SURFACE (COVE)

6" OPEN LED ADJUSTABLE DOWNLIGHT, 0-10V DIMMING TO 1%

LENSED LIGHT ENGINE & DRIVER ACCESSIBLE FROM BELOW

1. FIXTURES SHALL BE DESIGN LIGHTS CONSORTIUM (DLC) QUALIFIED PRODUCT.

SELF-FLANGED SEMI-SPECULAR REFLECTOR, CLEAR TRIM,

MATTE WHITE DIFFUSER, BRUSHED ALUMINUM FINISH

LINEAR LED COVE LIGHT, 0-10V DIMMING

LED DIMMABLE SCONCE

50 DEGREE ADJUSTABLE AIM

GENERAL NOTES

POLYCARBONATE HOUSING & LENS

J

Э

### GENERAL DEMOLITION NOTES

- CONTRACTOR SHALL VISIT THE SITE TO DETERMINE PRE-EXISTING CONDITIONS PRIOR TO SUBMISSION OF BID.
- ITEMS SCHEDULED FOR DEMOLITION ARE IDENTIFIED BY A HEAVY CONTINUOUS LINE TYPES ON DEMOLITION

PLANS. ITEMS SCHEDULED TO REMAIN ARE IDENTIFIED BY A THIN CONTINUOUS LINE TYPE.

- ALL EXISTING SYSTEMS ARE OPERATIONAL AT THE START OF CONSTRUCTION. CONTRACTOR SHALL REFER TO THE SEQUENCE OF CONSTRUCTION TO DETERMINE THE EXTENT OF DEMOLITION REQUIRED FOR EACH PHASE OF THE
- CONTRACTOR SHALL PROTECT ALL EXISTING ELECTRICAL, FIRE ALARM, SECURITY, AND TELECOMMUNICATIONS EQUIPMENT AND INSTALLATIONS NOT ASSOCIATED WITH THIS PROJECT. IF DAMAGED OR DISTURBED IN THE COURSE OF THE WORK, REMOVE DAMAGED PORTIONS AND INSTALL NEW PRODUCTS OF EQUAL CAPACITY, QUALITY AND FUNCTIONALITY.
- CONTRACTOR SHALL REMOVE LIGHTING FIXTURES ALONG WITH ASSOCIATED RACEWAYS AND CONDUCTORS BACK TO PREVIOUS DEVICE OR JUNCTION BOX UNLESS OTHERWISE NOTED. CONTRACTOR SHALL REUSE EXISTING RACEWAY AND BOXES IN PLACE WHERE APPLICABLE FOR NEW CONSTRUCTION. CONTRACTOR SHALL PROVIDE UPSTREAM AND DOWNSTREAM CONDUCTORS AND EXTEND RACEWAYS AS REQUIRED TO MAINTAIN SERVICE TO EXISTING LIGHTS NOT ASSOCIATED WITH THIS PROJECT. DAMAGED LIGHT FIXTURES SHALL BE REPLACED AT CONTRACTOR'S EXPENSE.
- CONTRACTOR SHALL REMOVE HVAC EQUIPMENT DISCONNECTS, STARTERS, DEVICES, AND CONTROLS ALONG WITH ASSOCIATED RACEWAYS AND CONDUCTORS BACK TO PREVIOUS DEVICE OR JUNCTION BOX UNLESS OTHERWISE NOTED. CONTRACTOR SHALL PROVIDE UPSTREAM AND DOWNSTREAM CONDUCTORS AND EXTEND RACEWAYS AS REQUIRED TO MAINTAIN SERVICE TO EXISTING HVAC EQUIPMENT NOT ASSOCIATED WITH THIS PROJECT. REFER TO DRAWINGS FOR HVAC ITEMS THAT SHALL BE REMOVED.
- PRIOR TO ANY PROJECT DEMOLITION OR ABATEMENT FOR EACH PHASE, CONTRACTOR SHALL VERIFY NORMAL OPERATION OF THE CURRENT FIRE ALARM SYSTEM, PROVIDE SENSITIVITY REPORT FOR ALL EXISTING DEVICES. PROVIDE COMPLETE ADDRESS LISTING FOR ALL DEVICES, AND PROVIDE AIR TIGHT PROTECTIVE MEASURES TO PROTECT THE EXISTING DEVICES THAT ARE INDICATED TO REMAIN. REFER TO DRAWINGS FOR ITEMS THAT SHALL REMAIN, REFER TO MANUFACTURER FOR METHOD OF AIR TIGHT PROTECTION (I.E. LATEX GLOVE, CLEAR WRAP, ETC.) CONTRACTOR SHALL NOTIFY THE ENGINEER IMMEDIATELY UPON DISCOVERY OF ANY DEFICIENCIES IN THE FIRE ALARM SYSTEM.
- CONTRACTOR SHALL CUT OFF OUT OF SIGHT, CAP, AND ABANDON IN PLACE ALL UNUSED DEMOLISHED CONDUITS THAT CANNOT BE REMOVED.
- CONTRACTOR IS RESPONSIBLE FOR REMOVING DEMO MATERIAL FROM PROJECT SITE AND DISPOSING OF PROPERLY. THE CONTRACTOR SHALL TURN OVER TO OWNER AFTER REMOVAL ANY EQUIPMENT THAT THE OWNER REQUEST TO SALVAGE.

#### **GENERAL PLAN NOTES**

- ALL ELECTRICAL WORK SHALL COMPLY WITH APPLICABLE CODES AND THE GOVERNMENTAL AUTHORITIES HAVING JURISDICTION. COORDINATE ALL WORK OTHER OWNER.
- VERIFY LOCATION AND DIMENSIONS OF ALL EQUIPMENT AND COORDINATE ALL WORK PRIOR TO THE START OF
- CONTRACTOR SHALL VISIT THE SITE TO DETERMINE PRE-EXISTING CONDITIONS PRIOR TO SUBMISSION OF BID.
- CONTRACTOR SHALL PROVIDE CONDUCTORS AND EXTEND RACEWAYS AS REQUIRED FOR CONNECTION TO NEW LIGHTING FIXTURES. REFER TO DRAWINGS FOR LIGHTING FIXTURE LOCATIONS, CIRCUIT DESTINATIONS, AND SWITCHING LOCATIONS.
- CONTRACTOR SHALL PROVIDE CONDUCTORS AND RACEWAYS AS REQUIRED FOR CONNECTION TO NEW WIRING DEVICES. REFER TO DRAWINGS FOR NEW DEVICE LOCATIONS AND CIRCUIT DESTINATIONS.
- 6. CONTRACTOR SHALL PROVIDE BLANK STAINLESS STEEL COVER PLATES FOR ALL EXISTING OUTLET BOXES THAT ARE NOT REUSED.
- CIRCUITS ARE 2#12, 1#12G, IN 3/4"C UNLESS OTHERWISE NOTED.
- BEFORE INSTALLING EQUIPMENT, CONTRACTOR SHALL MAKE FIELD MEASUREMENTS TO INSURE THAT ALL ITEMS OF EQUIPMENT FURNISHED WILL FIT INTO THE SPACE AS SHOWN ON THE DRAWINGS. WHERE EQUIPMENT WILL NOT FIT AS SHOWN ON THE DRAWINGS, PROVIDE A DRAWING TO THE ENGINEER FOR APPROVAL WITH A PROPOSED REVISED ARRANGEMENT BEFORE INSTALLING THE EQUIPMENT.
- WHERE THE CONDUCTOR LENGTH FROM THE PANEL TO THE FIRST DEVICE ON A 120V BRANCH CIRCUIT EXCEEDS 50 FEET, BRANCH CIRCUIT CONDUCTORS SHALL NOT BE SMALLER THAN #10 AWG TO THE FIRST DEVICE OR LIGHT
- 10. ALL BRANCH CIRCUITS SHALL CONTAIN AN EQUIPMENT GROUNDING CONDUCTOR. ALL EQUIPMENT SHALL BE GROUNDED PER THE NEC.
- 11. PROVIDE DEDICATED NEUTRAL FOR ALL SINGLE-POLE BRANCH CIRCUITS, UNLESS OTHERWISE NOTED ON PLANS.

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SEAL WILLIAM A. KEMP 3/15/19

KEY PLAN

SCALE

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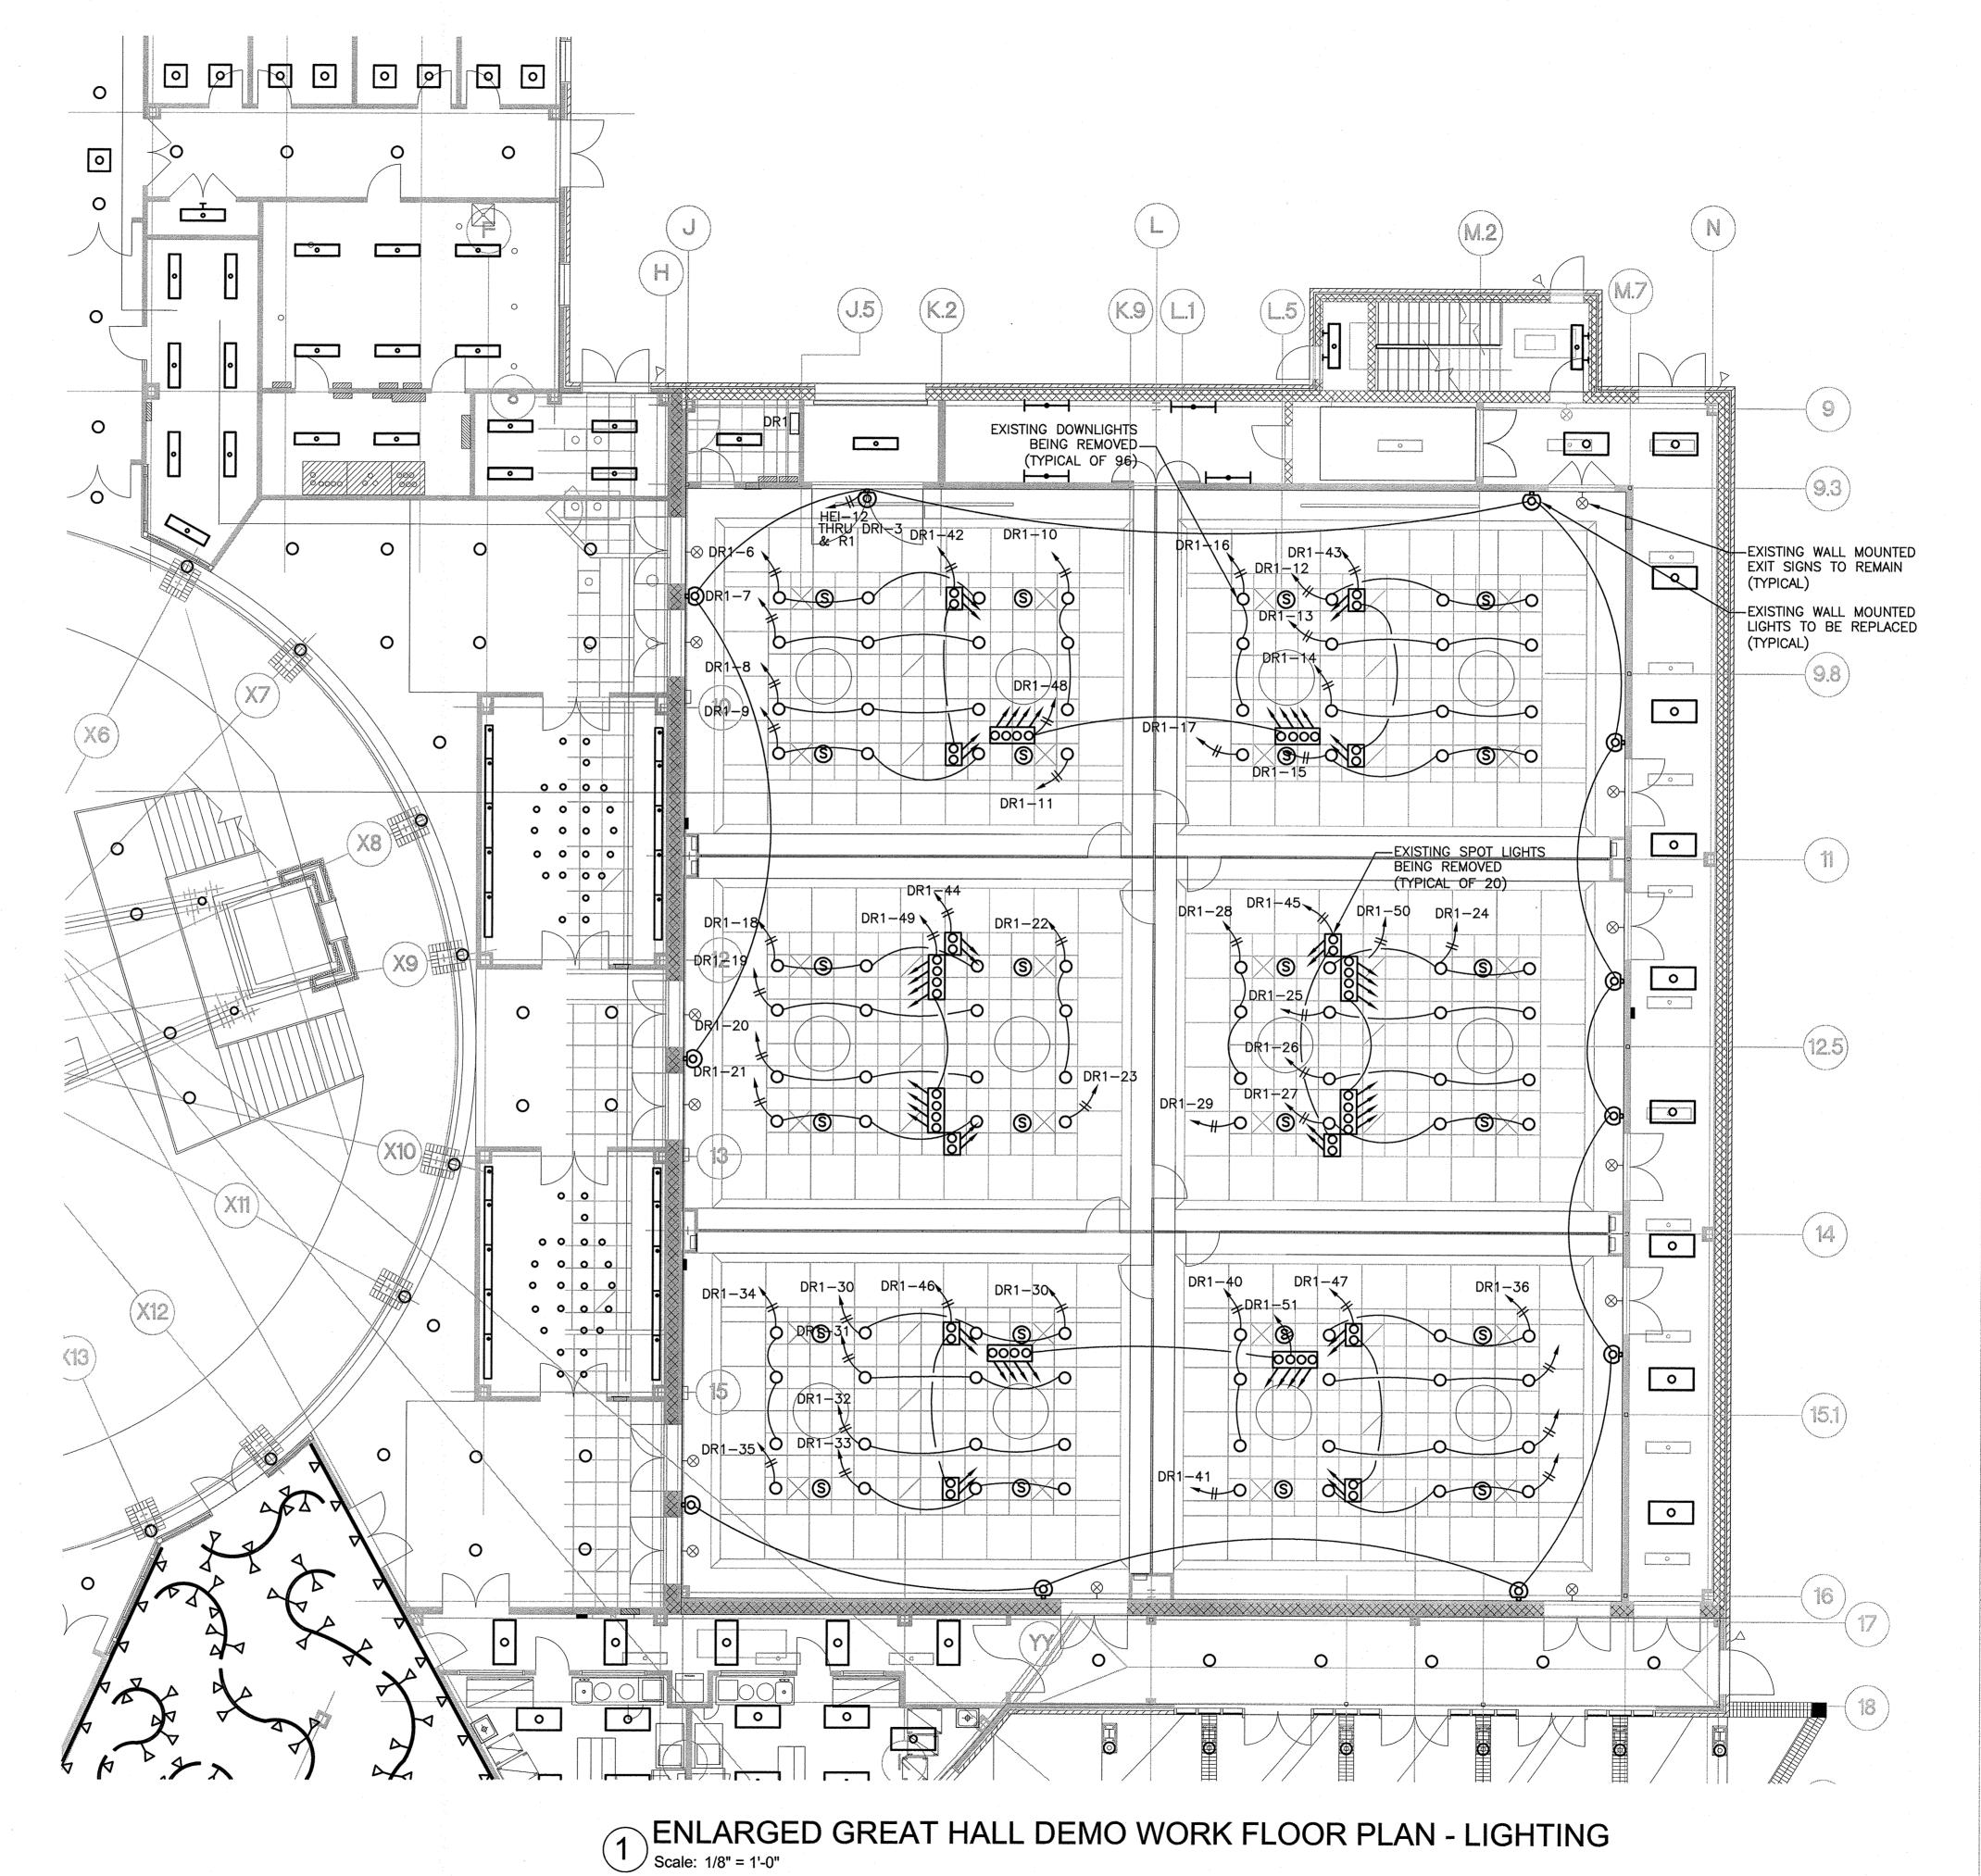
JANUARY 15, 2019 TITLE **ELECTRICAL** 

DEB Project Code # 885-18321-000 PROJECT NO.

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No. Description Date **REVISIONS** 

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**GREAT HALL DEMO WORK** LIGHTING PLAN

DEB Project Code # 885-18321-000 PROJECT NO. 50100160

E1.00

1 ENLARGED GREAT HALL NEW WORK FLOOR PLAN - LIGHTING
Scale: 1/8" = 1'-0"

**GENERAL NOTES** 

1. THE FOLLOWING CIRCUITS FROM DIMMING PANEL DR1 SHALL BE ABANDONED AND LABELED AS SPARE: 9, 10, 11, 42, 48, 13, 14, 15, 43, 21, 22, 23, 44, 49, 24, 26, 27, 45, 30, 32, 33, 46, 36, 38, 39, 47 AND 51.

### **KEYED NOTES:**

- 1) EXTEND EMERGENCY LIGHTING CIRCUIT 'HE1'-12, VIA DR1-3 AND REM-1 FROM EXISTING WALL SCONCE TO NEW LIGHT FIXTURES RECESSED IN CEILING. (1) NORMAL/EMERGENCY CIRCUIT #1 TO SENSOR IQ PANEL ROUTED THROUGH BCELTS. (1) RUN NORMAL/EMERG. DMX TO DATA RACK ROUTED THROUGH EDMX.
- 2 EXTEND EXISTING LIGHTING CIRCUIT DR1-6 FROM LOCATION OF EXISTING DOWNLIGHT TO NEW DOWNLIGHTS IN THIS AREA. (1) NORMAL CIRCUIT #2 TO IQ SENSOR IQ PANEL. (1) RUN NORMAL DMX TO DATA RACK.
- (3) EXTEND EXISTING LIGHTING CIRCUIT DR1-16 FROM LOCATION OF EXISTING DOWNLIGHT TO NEW DOWNLIGHTS IN THIS AREA. (1) NORMAL CIRCUIT #3 TO IQ SENSOR IQ PANEL. (1) RUN NORMAL DMX TO DATA RACK.
- 4 EXTEND EXISTING LIGHTING CIRCUIT DR1-18 FROM LOCATION OF EXISTING DOWNLIGHT TO NEW DOWNLIGHTS IN THIS AREA. (1) NORMAL CIRCUIT #4 TO IQ SENSOR IQ PANEL. (1) RUN NORMAL DMX TO DATA RACK.
- (5) EXTEND EXISTING LIGHTING CIRCUIT DR1-28 FROM LOCATION OF EXISTING DOWNLIGHT TO NEW DOWNLIGHTS IN THIS AREA. (1) NORMAL CIRCUIT #5 TO IQ SENSOR IQ PANEL. (1) RUN NORMAL DMX TO DATA RACK.
- (6) EXTEND EXISTING LIGHTING CIRCUIT DR1-34 FROM LOCATION OF EXISTING DOWNLIGHT TO NEW DOWNLIGHTS IN THIS AREA. (1) NORMAL CIRCUIT #6 TO IQ SENSOR IQ PANEL. (1) RUN NORMAL DMX TO DATA RACK.
- (7) EXTEND EXISTING LIGHTING CIRCUIT DR1-40 FROM LOCATION OF EXISTING DOWNLIGHT TO NEW DOWNLIGHTS IN THIS AREA. (1) NORMAL CIRCUIT #7 TO IQ SENSOR IQ PANEL. (1) RUN NORMAL DMX TO DATA RACK.
- (8) EXTEND EXISTING LIGHTING CIRCUIT DR1-7 FROM LOCATION OF EXISTING DOWNLIGHT TO NEW PENDANT FIXTURES IN THIS AREA. (1) NORMAL CIRCUIT #8 WITH 0-10V TO IQ SENSOR IQ PANEL.
- 9 EXTEND EXISTING LIGHTING CIRCUIT DR1-17 FROM LOCATION OF EXISTING DOWNLIGHT TO NEW PENDANT FIXTURES IN THIS AREA. (1) NORMAL CIRCUIT #9 WITH 0-10V TO IQ SENSOR IQ PANEL.
- DOWNLIGHT TO NEW PENDANT FIXTURES IN THIS AREA. (1) NORMAL CIRCUIT #10 WITH 0-10V TO IQ SENSOR IQ PANEL. (11) EXTEND EXISTING LIGHTING CIRCUIT DR1-29 FROM LOCATION OF EXISTING
- DOWNLIGHT TO NEW PENDANT FIXTURES IN THIS AREA. (1) NORMAL CIRCUIT #11
- (12) EXTEND EXISTING LIGHTING CIRCUIT DR1-35 FROM LOCATION OF EXISTING DOWNLIGHT TO NEW PENDANT FIXTURES IN THIS AREA. (1) NORMAL CIRCUIT #12 WITH 0-10V TO IQ SENSOR IQ PANEL.
- (13) EXTEND EXISTING LIGHTING CIRCUIT DR1-41 FROM LOCATION OF EXISTING DOWNLIGHT TO NEW PENDANT FIXTURES IN THIS AREA. (1) NORMAL CIRCUIT #13 WITH 0-10V TO IQ SENSOR IQ PANEL.
- EXTEND EXISTING LIGHTING CIRCUIT DR1-8 FROM LOCATION OF EXISTING DOWNLIGHT TO NEW RECESSED WALL WASH FIXTURES IN THIS AREA.


  (1) NORMAL CIRCUIT #14 TO IQ SENSOR IQ PANEL. (1) RUN NORMAL DMX TO
- 15) EXTEND EXISTING LIGHTING CIRCUIT DR1-12 FROM LOCATION OF EXISTING DOWNLIGHT TO NEW RECESSED WALL WASH FIXTURES IN THIS AREA. (1) NORMAL CIRCUIT #15 TO IQ SENSOR IQ PANEL. (1) RUN NORMAL DMX TO DATA RACK.
- (16) EXTEND EXISTING LIGHTING CIRCUIT DR1-20 FROM LOCATION OF EXISTING DOWNLIGHT TO NEW RECESSED WALL WASH FIXTURES IN THIS AREA. (1) NORMAL CIRCUIT #16 TO IQ SENSOR IQ PANEL. (1) RUN NORMAL DMX TO DÁTA RACK.
- 17 EXTEND EXISTING LIGHTING CIRCUIT DR1-25 FROM LOCATION OF EXISTING DOWNLIGHT TO NEW RECESSED WALL WASH FIXTURES IN THIS AREA. (1) NORMAL CIRCUIT #17 TO IQ SENSOR IQ PANEL. (1) RUN NORMAL DMX TO DATA RACK.
- 18) EXTEND EXISTING LIGHTING CIRCUIT DR1-31 FROM LOCATION OF EXISTING DOWNLIGHT TO NEW RECESSED WALL WASH FIXTURES IN THIS AREA. (1) NORMAL CIRCUIT #18 TO IQ SENSOR IQ PANEL. (1) RUN NORMAL DMX TO DATA RACK.
- (19) EXTEND EXISTING LIGHTING CIRCUIT DR1-37 FROM LOCATION OF EXISTING DOWNLIGHT TO NEW RECESSED WALL WASH FIXTURES IN THIS AREA. (1) NORMAL CIRCUIT #19 TO IQ SENSOR IQ PANEL. (1) RUN NORMAL DMX TO

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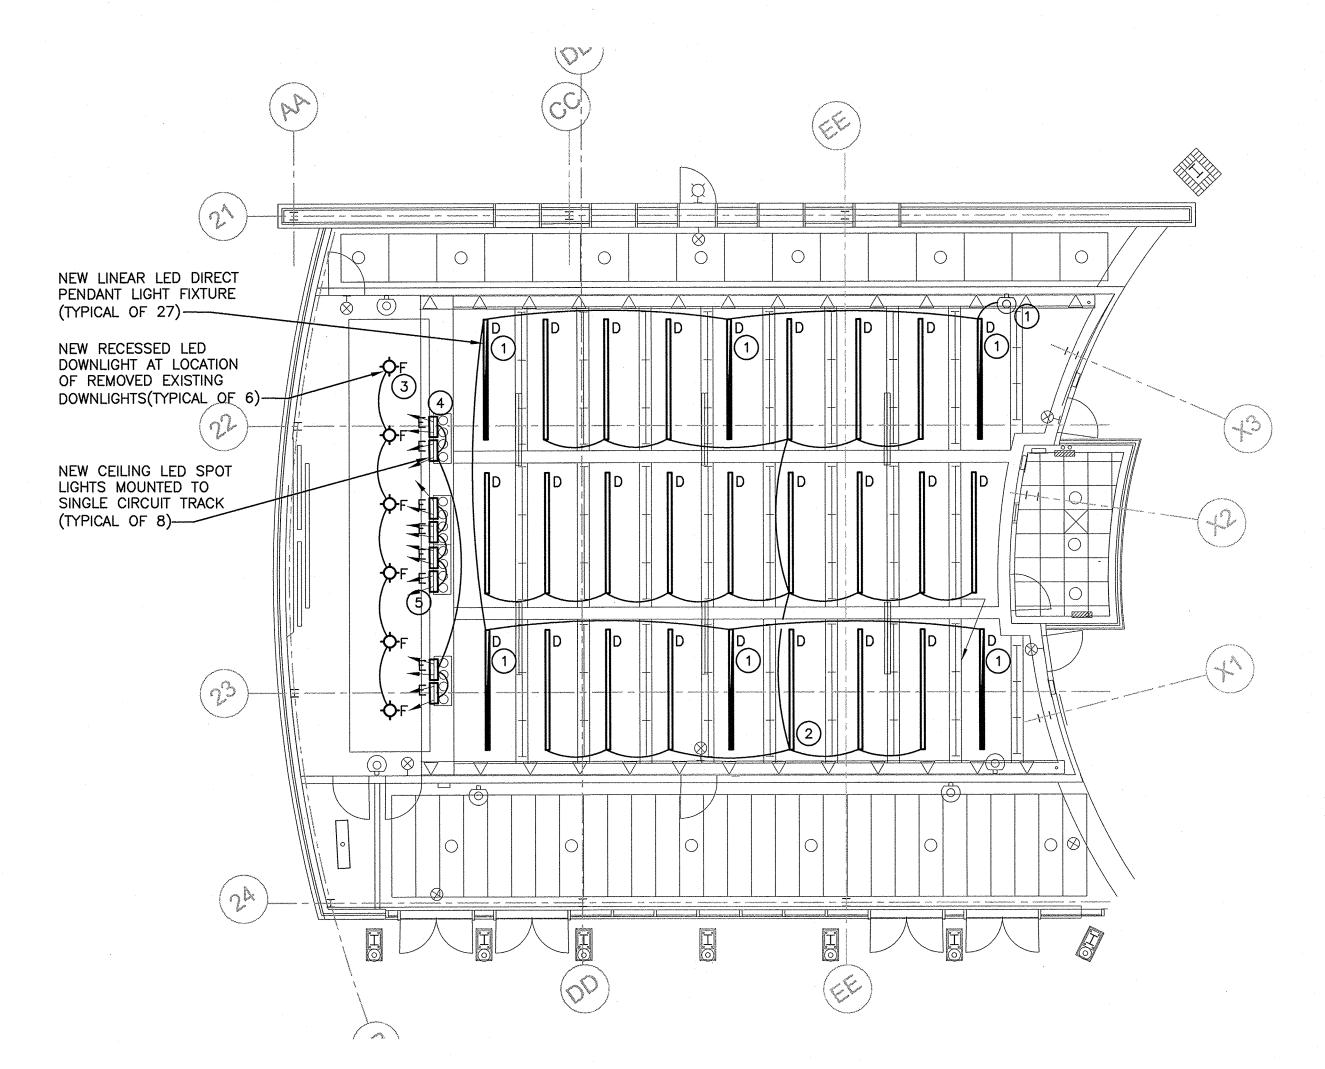
**GREAT HALL NEW WORK** LIGHTING PLAN

DEB Project Code # 885-18321-000 PROJECT NO. 50100160

E1.01

EXECUTIVE AUDITORIUM DEMO WORK FLOOR PLAN - LIGHTING

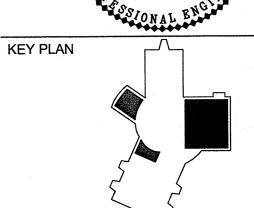Scale: 1/8" = 1'-0"



EXECUTIVE AUDITORIUM NEW WORK FLOOR PLAN - LIGHTING

Scale: 1/8" = 1'-0"

#### **GENERAL NOTES**

- 1. THE FOLLOWING CIRCUITS FROM DIMMING PANEL DR2 SHALL BE ABANDONED AND LABELED AS SPARE: 5.
- 2. THE EXISTING LUTRON DIMMING SYSTEM SHALL CONTROL THE NEW AND EXISTING LIGHTS IN THE EXECUTIVE AUDITORIUM.
- 3. FIELD COORDINATE THE LOCATIONS OF LIGHT FIXTURE TYPE D
  PENDANTS WITH EXISTING ELEMENTS TO REMAIN IN THE EXISTING
  CEILINGS

#### **KEYED NOTES:**


- 1 EXTEND EMERGENCY LIGHTING CIRCUIT 'H1'-2, VIA DR2-6 AND REM2 FROM EXISTING WALL SCONCE TO NEW LINEAR PENDANT LIGHT FIXTURES.
- 2 EXTEND EXISTING LIGHTING CIRCUIT 'H1'-11, VIA DR2-25 FROM LOCATION OF EXISTING COVE LIGHT TO NEW LINEAR PENDANT LIGHTS. PROVIDE LUTRON #GRX-TVI O-10V INTERFACE MODULE FOR COMPATIBILITY OF NEW LED LIGHT FIXTURES TO EXISTING DIMMING SYSTEM.
- 3 EXTEND EXISTING LIGHTING CIRCUIT DR2-1 FROM LOCATION OF EXISTING DOWNLIGHT TO NEW DOWNLIGHTS. PROVIDE LUTRON #GRX-TVI 0-10V INTERFACE MODULE FOR COMPATIBILITY OF NEW LED LIGHT FIXTURES TO EXISTING DIMMING SYSTEM
- 4 EXTEND EXISTING LIGHTING CIRCUIT DR2-3 FROM LOCATION OF EXISTING SPOTLIGHTS TO NEW SPOTLIGHTS. PROVIDE LUTRON #GRX-TVI O-10V INTERFACE MODULE FOR COMPATIBILITY OF NEW LED LIGHT FIXTURES TO EXISTING DIMMING SYSTEM.
- 5 EXTEND EXISTING LIGHTING CIRCUIT DR2-4 FROM LOCATION OF EXISTING SPOTLIGHTS TO NEW SPOTLIGHTS. PROVIDE LUTRON #GRX-TVI O-10V INTERFACE MODULE FOR COMPATIBILITY OF NEW LED LIGHT FIXTURES TO EXISTING DIMMING SYSTEM.

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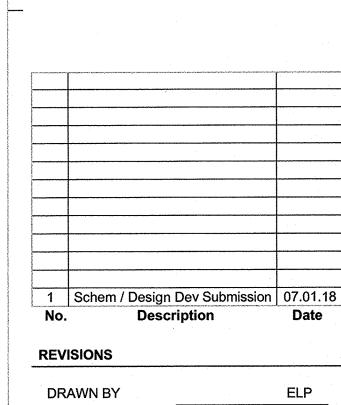
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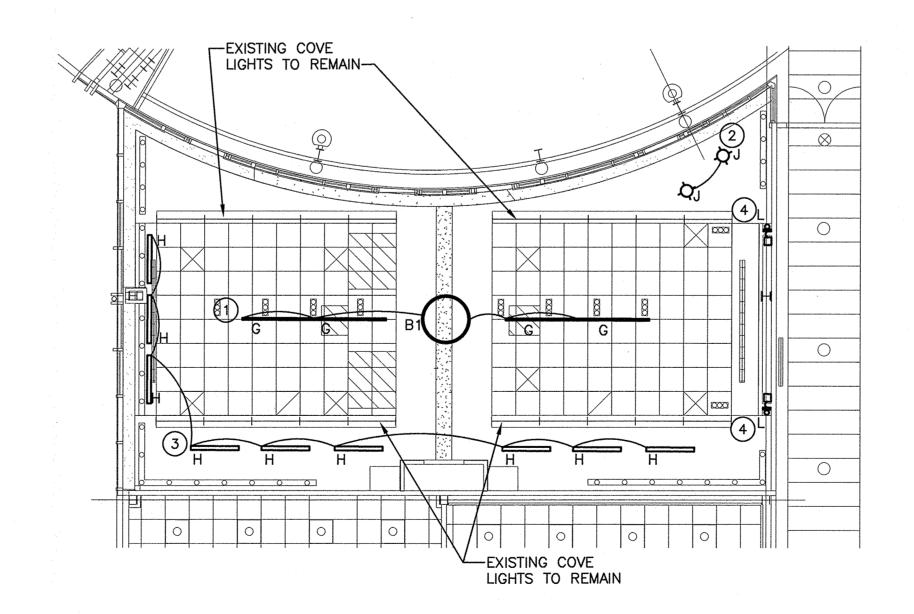
EXECUTIVE AUDITORIUM LIGHTING PLANS

DEB Project Code # 885-18321-000
PROJECT NO. 50100160

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S

EXECUTIVE CONFERENCE ROOM DEMO WORK FLOOR PLAN - LIGHTING
Scale: 1/8" = 1'-0"

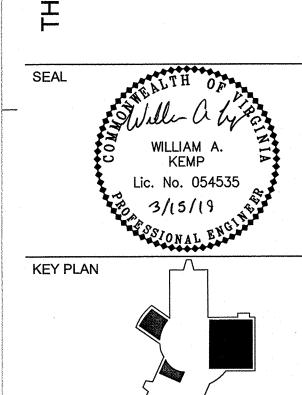

#### **GENERAL NOTES**

- 1. THE FOLLOWING CIRCUITS FROM DIMMING PANEL DR3 SHALL BE ABANDONED AND LABELED AS SPARE: 2, 3, 4, 18, 19, 21 AND 22.
- 2. THE EXISTING LUTRON DIMMING SYSTEM SHALL CONTROL THE NEW AND EXISTING LIGHTS IN THE EXECUTIVE CONFERENCE ROOM.


#### **KEYED NOTES:**


- 1 EXTEND EXISTING LIGHTING CIRCUIT DR3-1 FROM LOCATION OF EXISTING RECESSED SPOTLIGHT TO NEW LINEAR PENDANT LIGHTS. PROVIDE LUTRON #GRX-TVI O-10V INTERFACE MODULE FOR COMPATIBILITY OF NEW LED LIGHT FIXTURES TO EXISTING DIMMING SYSTEM.
- (2) EXTEND EXISTING LIGHTING CIRCUIT DR3-20 FROM LOCATION OF EXISTING TRACKLIGHT TO NEW RECESSED ADJUSTABLE DOWNLIGHTS.PROVIDE LUTRON #GRX-TVI O-10V INTERFACE MODULE FOR COMPATIBILITY OF NEW LED LIGHT FIXTURES TO EXISTING DIMMING SYSTEM.
- (3) EXTEND EXISTING LIGHTING CIRCUIT DR3-17 FROM LOCATION OF EXISTING TRACKLIGHT TO NEW RECESSED LINEAR WALL WASH FIXTURES.PROVIDE LUTRON #GRX-TVI O-10V INTERFACE MODULE FOR COMPATIBILITY OF NEW LED LIGHT FIXTURES TO EXISTING DIMMING SYSTEM.
- SWAP OUT EXISTING CONCEALED FLUORESCENT TUBES TO CONCEALED LED STRIPS. VERIFY FIXTURE CONTROL WIRING REQUIREMENTS PRIOR TO ORDERING FIXTURES TO INSURE EXISTING CONTROL WIRING IS COMPATIBLE WITH 0-10V

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**EXECUTIVE** CONF. ROOM LIGHTING PLANS

DEB Project Code # 885-18321-000 PROJECT NO. 50100160

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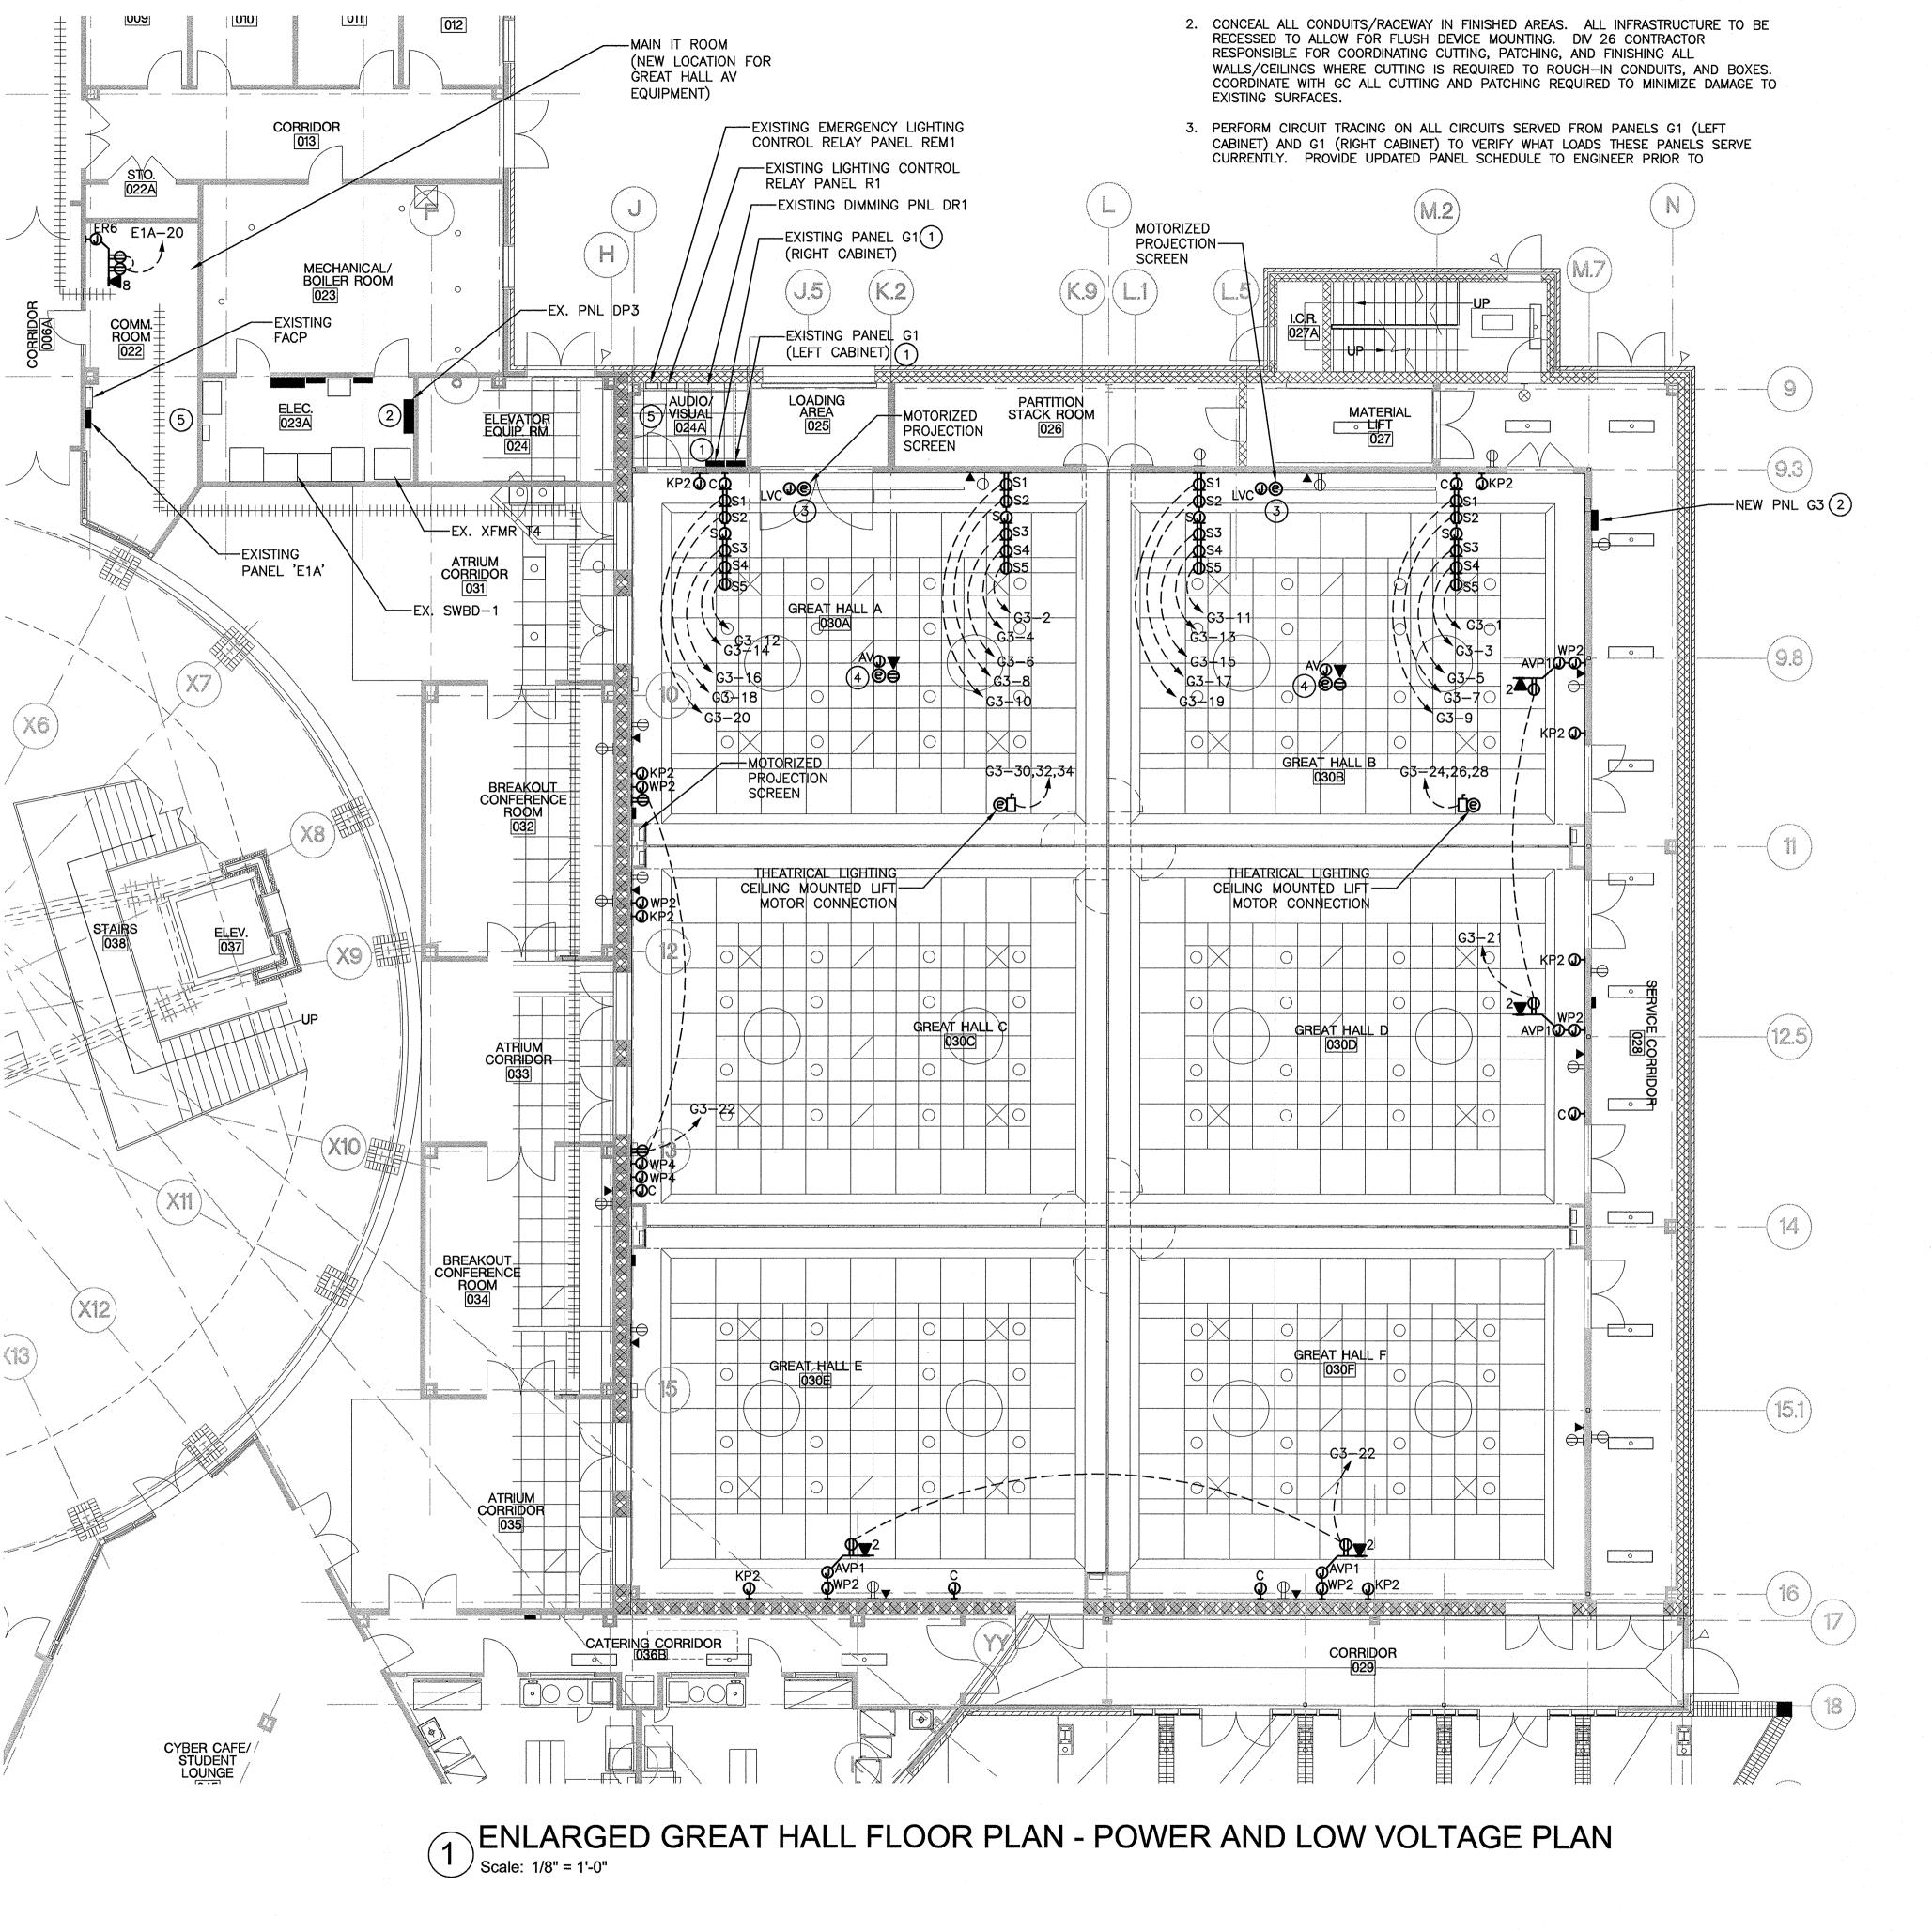
EXECUTIVE CONFERENCE ROOM NEW WORK FLOOR PLAN - LIGHTING

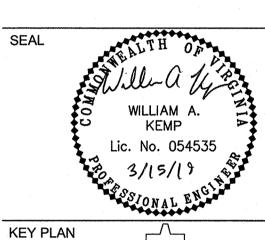Scale: 1/8" = 1'-0"

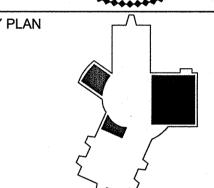**KEYED NOTES:** 

- 1) PERFORM CIRCUIT TRACING ON ALL CIRCUITS SERVED FROM PANELS 'G1-LEFT' AND 'G1-RIGHT' TO VERIFY EXISTING LOADS SERVED FROM THESE PANELS. THIS SHOULD BE DONE PRIOR TO CONSTRUCTION. PROVIDE AN UPDATED PANEL SCHEDULE TO ENGINEER AND MARKUP OF THE ELECTRICAL DRAWING INDICATING WHERE THESE CIRCUITS ARE LOCATED.
- 2 FEEDER THAT SERVES NEW PANEL 'G3' TO BE ROUTED FROM MAIN ELECTRICAL ROOM THROUGH COMM. ROOM AND VERTICALLY UP TO SECOND FLOOR COMM. ROOM. FROM THIS ROOM ROUTE FEEDER HORIZONTALLY ABOVE ACCESSIBLE CEILINGS TO THE SECOND FLOOR SERVICE CORRIDOR. CONDUIT TO TURN DOWN VERTICALLY UNTIL IT REACHES THE FIRST FLOOR SERVICE CORRIDOR WHERE NEW PANEL 'G3' IS TO BE INSTALLED.
- 3 SERVE NEW MOTORIZED PROJECTOR SCREEN FROM EXISTING BRANCH CIRCUIT WIRING THAT SERVED THE ORIGINAL MOTORIZED PROJECTOR SCREEN REMOVED DURING DEMOLITION. EXTEND 2#12, #12G WIRING AND 3/4"CONDUIT AS NECESSARY TO SERVE THE NEW MOTOR CONNECTION.
- 4 SERVE NEW PROJECTOR LIFT FROM EXISTING BRANCH CIRCUIT WIRING THAT SERVED THE ORIGINAL PROJECTOR LIFT REMOVED DURING DEMOLITION. EXTEND 2#12, #12G WIRING AND 3/4"CONDUIT AS NECESSARY TO SERVE THE NEW MÖTOR CONNECTION. COORDINATE LOCATION OF NEW DUPLEX RECEPTACLE AND DATA OUTLET SO THEY ARE MOUNTED ON LIFT TO ALLOW FOR PROJECTOR TO REMAIN CONNECTED EVEN WHEN LIFT IS FULLY EXTENDED. SERVE NEW RECEPTACLE FROM THE EXISTING CIRCUIT THAT CURRENTLY SERVES THE PROJECTOR RECEPTACLE. EXTEND DATA AND A/V INFRASTRUCTURE AS NECESSARY TO SERVE PROJECTOR ON NEW LIFT. PROJECTOR LIFT FURNISHED BY A/V CONTRACTOR AND INSTALLED BY DIV 26 CONTRACTOR.
- 5) PROVIDE (3)2"C FROM CURRENT GREAT HALL A/V ROOM ABOVE CEILING TO TO THE MAIN COMMUNICATION ROOM FOR NETWORKING OF A/V EQUIPMENT. CONDUITS TO BE ROUTED TO 2ND FLOOR AND ABOVE CEILING TO THE COMMUNICATIONS ROOM TO END IN THE MAIN IT ROOM ON THE FIRST FLOOR.

	ELECTRICAL DEVICES AND	INFRASTRUCTU	RE LEGEND
SYMBOL	DESCRIPTION	MOUNTING HEIGHT	INFRASTRUCTURE PROVISIONS
<b>Ю</b> S1	RECESSED WALL MOUNTED DUPLEX RECEPTACLE (FOR *SUBWOOFER)	9'-9" AFF TO CENTER OF BOX	3/4"C FROM SOURCE TO DEVICE
₩ <sub>S2</sub>	RECESSED WALL MOUNTED DUPLEX RECEPTACLE (FOR *SUBWOOFER)	11'-3" AFF TO CENTER OF BOX	3/4"C FROM SOURCE TO DEVICE
₩ <sub>S3</sub>	RECESSED WALL MOUNTED DUPLEX RECEPTACLE (FOR *SPEAKERS)	12'-10" AFF TO CENTER OF BOX	3/4"C FROM SOURCE TO DEVICE
<b>Ю</b> S4	RECESSED WALL MOUNTED DUPLEX RECEPTACLE (FOR *SPEAKERS)	14'-7" AFF TO CENTER OF BOX	3/4"C FROM SOURCE TO DEVICE
₩ <sub>S5</sub>	RECESSED WALL MOUNTED DUPLEX RECEPTACLE (FOR *SPEAKERS)	16'-4" AFF TO CENTER OF BOX	3/4"C FROM SOURCE TO DEVICE
<b>e</b>	DIRECT WIRED EQUIPMENT ELECTRICAL CONNECTION	COORDINATE WITH EQUIPMENT	3/4"C FROM SOURCE TO DEVICE
₩ <sub>AVP1</sub>	RECESSED CHIEF PAC526 BACK BOX (FURNISHED BY AV CONTRACTOR, INSTALLED BY DIV 26)	6'-9" AFF TO CENTER OF BOX	1-1/4"C IN WALL STUBBED ABOVE ACCESSIBLE CEILING
ЮС	RECESSED 2-GANG JUNCTION BOX (FOR *CAMERA)	6'-9" AFF TO CENTER OF BOX	1-1/4"C IN WALL STUBBED ABOVE ACCESSIBLE CEILING
⊷ <sub>KP2</sub>	RECESSED CRESTRON BACK BOX (FURNISHED BY AV CONTRACTOR, INSTALLED BY DIV 26)	4'-3" AFF TO CENTER OF BOX	1-1/4"C FROM SOURCE TO DEVICE
<b>O</b> LVC	1-GANG JUNCTION BOX ABOVE CEILING (FOR *LOW VOLTAGE CONTROLS OF PROJECTOR SCREEN)	MOUNTED TO THE SIDE OF THE PROJECTOR SCREEN HOUSING	1-1/4"C FROM CORRESPONDING 'KP2' JUNCTION BOX TO THIS BOX
юs	RECESSED 2-GANG JUNCTION BOX (FOR *SPEAKER CLUSTER)	12'-10" AFF TO CENTER OF BOX	1-1/2"C IN WALL STUBBED ABOVE ACCESSIBLE CEILING
₩ <sub>WP2</sub>	RECESSED 2-GANG JUNCTION BOX (FOR *AV WALL PLATE)	1'-6" AFF TO CENTER OF BOX	1-1/4"C IN WALL STUBBED ABOVE ACCESSIBLE CEILING
ю <sub>WP4</sub>	RECESSED 4-GANG JUNCTION BOX (FOR *AV WALL PLATE)	1'-6" AFF TO CENTER OF BOX	1-1/4"C IN WALL STUBBED ABOVE ACCESSIBLE CEILING
MAVP1 May 2	RECESSED CHIEF PAC526 BACK BOX (FURNISHED BY AV CONTRACTOR, INSTALLED BY DIV 26). DUPLEX RECEPTACLE AND 2—GANG BOX FOR DATA OUTLET RECESSED IN BACKBOX (PROVIDED BY DIV 26). DATA OUTLET FACEPLATE PROVIDED BY AV CONTRACTOR.	6'-4" AFF TO CENTER OF BACK BOX. RECEPTACLE RECESSED IN TOP OF BOX.	PROVIDE 3/4"C FROM SOURCE TO RECEPTACLE. PROVIDE 1 1/4"C TO NETWORK EQUIPMENT IN IDF ROOM. PROVIDE 1 1/4"C TO AV BACK BOX.
ER6	SURFACE MOUNTED 12"x12" JUNCTION BOX (PROVIDED BY DIV 26). DUPLEX RECEPTACLES AND 2—GANG BOX FOR DATA OUTLET RECESSED IN JUNCTION BOX.	6'-4" AFF TO CENTER OF JUNCTION BOX. RECEPTACLE AND DATA OUTLET RECESSED IN TOP OF BOX.	PROVIDE (1) 3/4"C FROM SOURCE TO SERVE RECEPTACLES. PROVIDE 2"C FROM ABOVE ACCESSIBLE CEILING TO DATA OUTLET. PROVIDE 1 1/4"C TO AV BACK BOX.
■ <sub>X</sub>	STANDARD FLUSH MOUNT DATA OUTLET IN 2-GANG BACK BOX. (FACEPLATE AND CABLES PROVIDED BY AV CONTRACTOR)	1'-6" AFF TO CENTER OF BOX	1 1/4"C IN WALL STUBBED ABOVE ACCESSIBLE CEILING.



**GENERAL NOTES:** 

1. COORDINATE EXACT LOCATION OF DEVICES PRIOR TO ROUGH-IN WITH AV CONTRACTOR.

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1 | Schem / Design Dev Submission | 07.01.1

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APPROVED BY **CHECKED BY** JANUARY 15, 2019

TITLE

**GREAT HALL POWER AND LOW VOLTAGE PLAN** 

DEB Project Code # 885-18321-000 PROJECT NO.

E2.01

#### **GENERAL NOTES:**

- 1. COORDINATE EXACT LOCATION OF DEVICES PRIOR TO ROUGH-IN WITH AV CONTRACTOR.
- 2. CONCEAL ALL CONDUITS/RACEWAY IN FINISHED AREAS. ALL INFRASTRUCTURE TO BE RECESSED TO ALLOW FOR FLUSH DEVICE MOUNTING. DIV 26 CONTRACTOR RESPONSIBLE FOR COORDINATING CUTTING, PATCHING, AND FINISHING ALL WALLS/CEILINGS WHERE CUTTING IS REQUIRED TO ROUGH—IN CONDUITS, AND BOXES. COORDINATE WITH GC ALL CUTTING AND PATCHING REQUIRED TO MINIMIZE DAMAGE TO EXISTING SURFACES.
- 3. PANEL 'CF' IS LOCATED IN STORAGE ROOM 022 ON THE FIRST FLOOR AT THE BACK OF THE BOOKSTORE. PANEL 'CF' CURRENTLY SERVES EXISTING CIRCUITS INSIDE THE BOARDROOM.


	ELECTRICAL DEVICES AND	INFRASTRUCTU	RE LEGEND
SYMBOL	DESCRIPTION	MOUNTING HEIGHT	INFRASTRUCTURE PROVISIONS
©	DIRECT WIRED EQUIPMENT ELECTRICAL CONNECTION	COORDINATE WITH EQUIPMENT	3/4"C FROM SOURCE TO DEVICE
юс	RECESSED 2-GANG JUNCTION BOX (FOR *CAMERA)	6'-9" AFF TO CENTER OF BOX	1-1/4"C IN WALL STUBBED ABOVE ACCESSIBLE CEILING
⊬ <b>o</b> <sub>AV2</sub>	RECESSED 2-GANG JUNCTION BOX (FOR *TV WALL)	5'-10" AFF TO CENTER OF BOX	1-1/4"C IN WALL STUBBED ABOVE ACCESSIBLE CEILING
HQ <sup>AVP1</sup> H⊕	RECESSED CHIEF PAC526 BACK BOX (FURNISHED BY AV CONTRACTOR, INSTALLED BY DIV 26). DUPLEX RECEPTACLE RECESSED IN BACKBOX (PROVIDED BY DIV 26).	5'-5-3/4" AFF TO CENTER OF BACK BOX. RECEPTACLE RECESSED IN TOP OF BOX.	PROVIDE 3/4"C FROM SOURCE TO RECEPTACLE. PROVIDE 1-1/4"C TO AV BACK BOX.
ER6	SURFACE MOUNTED 12"x12" JUNCTION BOX (PROVIDED BY DIV 26). DUPLEX RECEPTACLES AND 8—PORT DATA OUTLET RECESSED IN JUNCTION BOX.	6'-4" AFF TO CENTER OF JUNCTION BOX. RECEPTACLE AND DATA OUTLET RECESSED IN TOP OF BOX.	PROVIDE (1) 3/4"C FROM SOURCE TO SERVE RECEPTACLES. PROVIDE 2"C FROM ABOVE ACCESSIBLE CEILING TO DATA OUTLET. AND 1-1/4"C TO AV BACK BOX.
►x	STANDARD FLUSH MOUNT DATA OUTLET IN 2-GANG BACK BOX. 'X' SUBSCRIPT INDICATES NUMBER OF DATA PORTS. NO SUBSCRIPT INDICATES 2 PORT DATA OUTLET.	1'-6" AFF TO CENTER OF BOX	1-1/4"C IN WALL STUBBED ABOVE ACCESSIBLE CEILING.

#### **DEMO WORK KEYED NOTES:**

REMOVE EXISTING QUAD RECEPTACLE AND DATA OUTLET LOCATED AT EXISTING A/V RACK. REMOVE BRANCH CIRCUIT WIRING AND CONDUIT BACK TO NEAREST JUNCTION BOX ABOVE ACCESSIBLE CEILING. REMOVE DATA CABLING AND CONDUIT IN ITS ENTIRETY. UPDATE PANEL SCHEDULE IN PANEL 'CF' TO INDICATE CIRCUIT IS NO LONGER IN USE.


#### **KEYED NOTES:**

1 EXISTING DUPLEX RECEPTACLE UTILIZED TO SERVE LED TV WALL. RECEPTACLE MADE AVAILABLE UPON REMOVAL OF EXISTING TV.

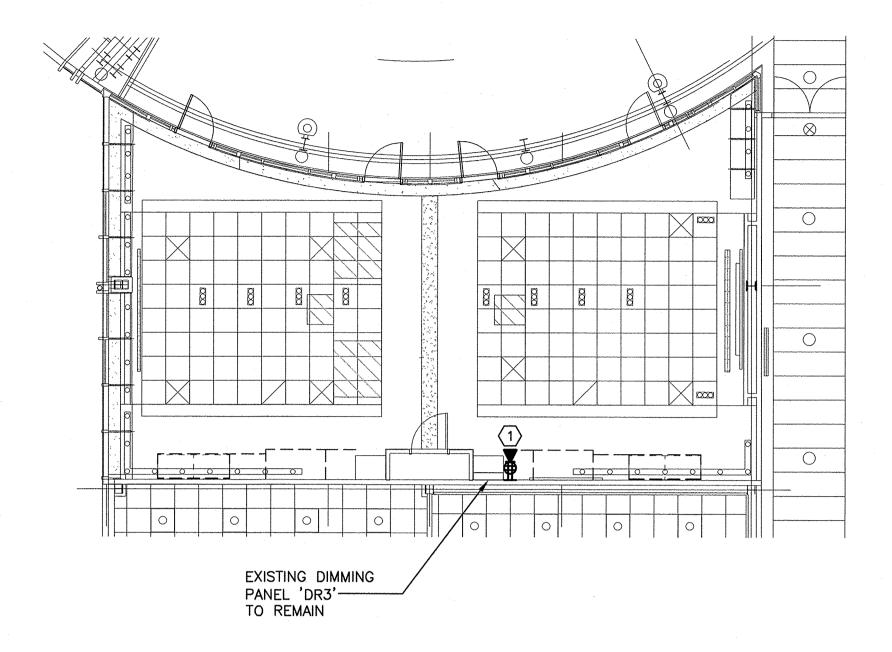

EXECUTIVE CONFERENCE ROOM DEMO WORK FLOOR PLAN - POWER

Scale: 1/8" = 1'-0"

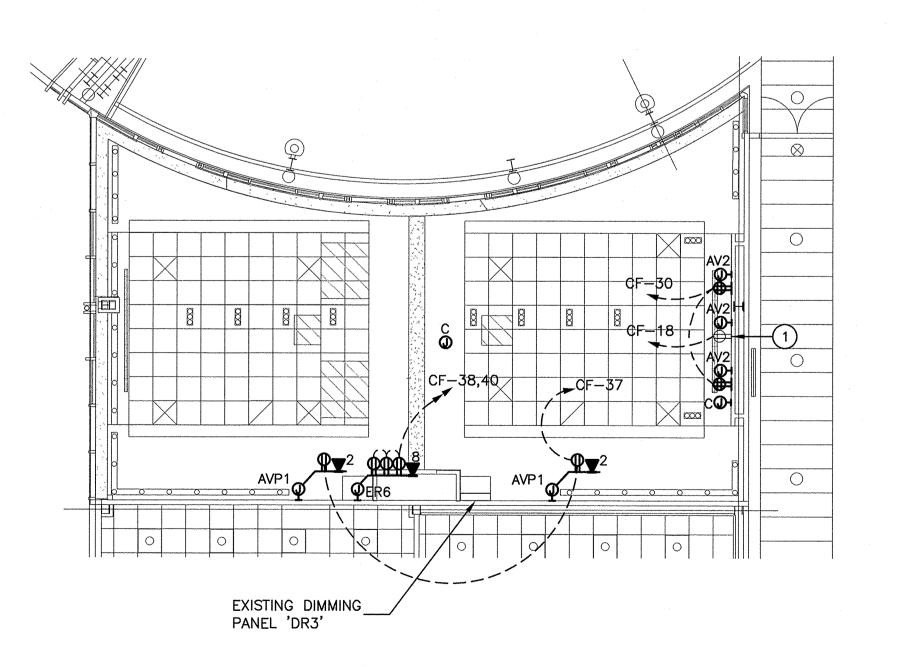

2 EXECUTIVE CONFERENCE ROOM NEW WORK FLOOR PLAN - POWER Scale: 1/8" = 1'-0"



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> 150 SLAYTON AVENUE DANVILLE, VA 24540

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ROVEMENTS

CONFERENCE FA
IMPROVEMEN

SEAL

WILLIAM A.

KEMP

Lic. No. 054535

3/15/19

KEY PLAN

.

As indicated

SCALE

1 Schem / Design Dev Submission 07.01.18
No. Description Date

REVISIONS

DRAWN BY ELP
APPROVED BY WAK
CHECKED BY WAK
DATE JANUARY 15, 2019

EXECUTIVE CONF. ROOM POWER PLANS

DEB Project Code # 885-18321-000
PROJECT NO. 50100160

E2.03


### **KEYED NOTES:**


- EXISTING 42 CIRCUIT PANEL 'I' TO BE REPLACED WITH A 54 CIRCUIT PANELBOARD TO SUPPORT ADDITIONAL AV CIRCUITS. EXISTING FEEDER THAT SERVES PANEL AS WELL AS BRANCH CIRCUITS SERVED FROM PANEL TO BE RECONNECTED TO NEW PANEL.
- 2 EXISTING PANEL 'DP3' SERVES POWER TO THE GREAT HALL AND EXECUTIVE AUDITORIUM AS WELL AS OTHER AREAS SUCH AS THE LOBBY. INSTALLATION OF THE NEW BREAKER IN EXISTING PANEL 'DP3' WILL REQUIRE THIS DISTRIBUTION PANEL BE SHUTDOWN. COORDINATE WITH BUILDING OWNER PRIOR TO SHUTDOWN TO VERIFY THERE ARE NO UNEXPECTED INTERRUPTIONS OF POWER TO THE ESSENTIAL SPACES OF THE FACILITY WHEN THEY ARE IN USE.

LOAD SUMMARY I	PANEL DRI
DESCRIPTION	DEMAND LOAD
EXISTING LOAD REMOVED	-50.6 kVA
LOAD ADDED	10.72 kVA
NET CHANGE =	-39.88 kVA
SOURCE CAPACITY @ 208V	400.0 A

LOAD SUMMARY PAI	NEL DR2
DESCRIPTION	DEMAND LOAD
EXISTING LOAD REMOVED	-9.65 kVA
LOAD ADDED	2.25 kVA
NET CHANGE =	-7.40 kVA
SOURCE CAPACITY @ 208V	200.0 A

LOAD SUMMARY PAI	NEL DR3									
DESCRIPTION DEMAND LOAD										
EXISTING LOAD REMOVED	-3.17 kVA									
LOAD ADDED	0.71 kVA									
NET CHANGE =	-2.46 kVA									
SOURCE CAPACITY @ 208V	100.0 A									

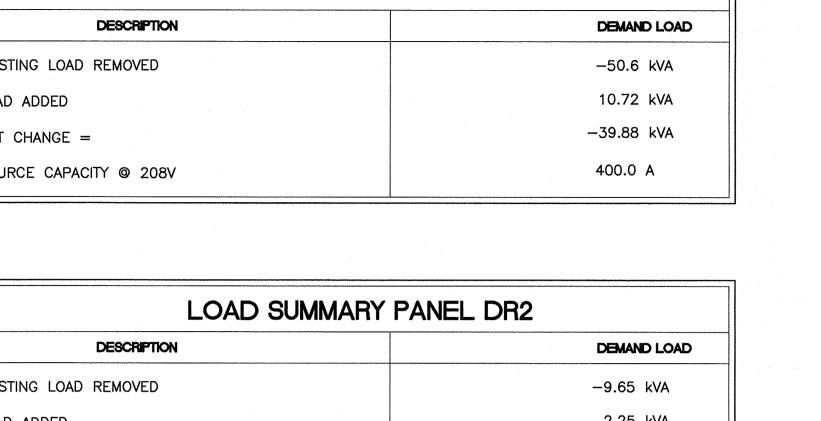

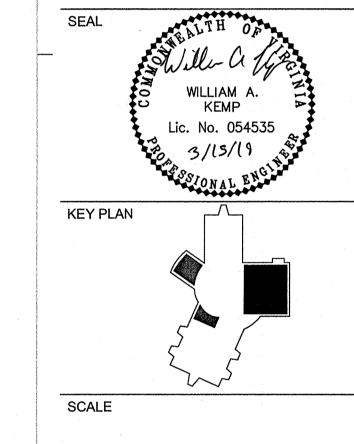


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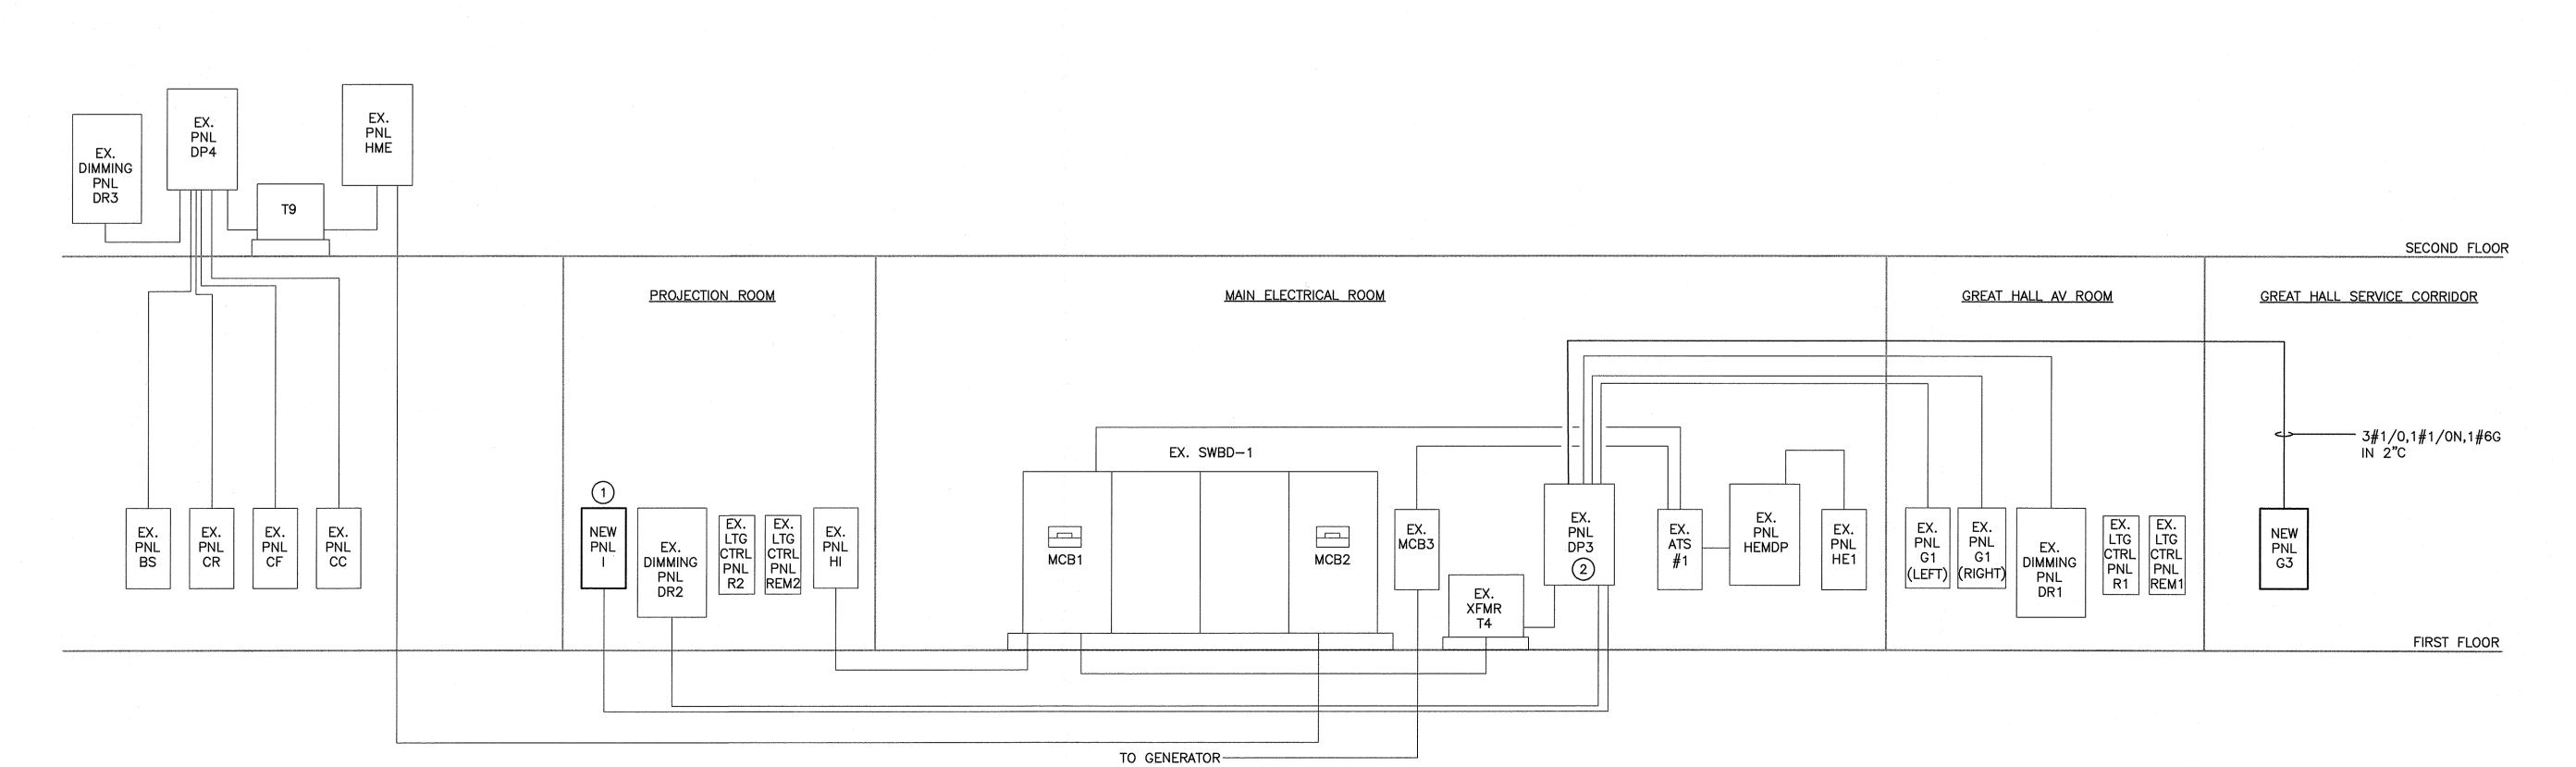



As indicated

RISER	

DEB Project Code # 885-18321-000 PROJECT NO. 50100160

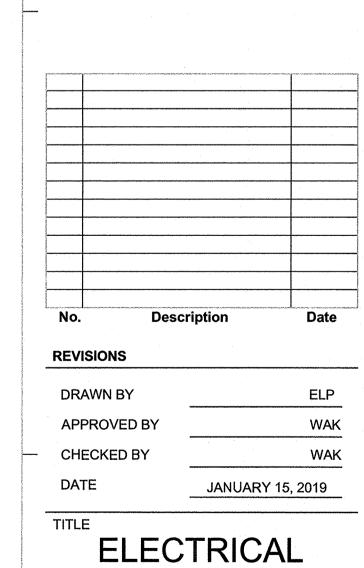E3.00



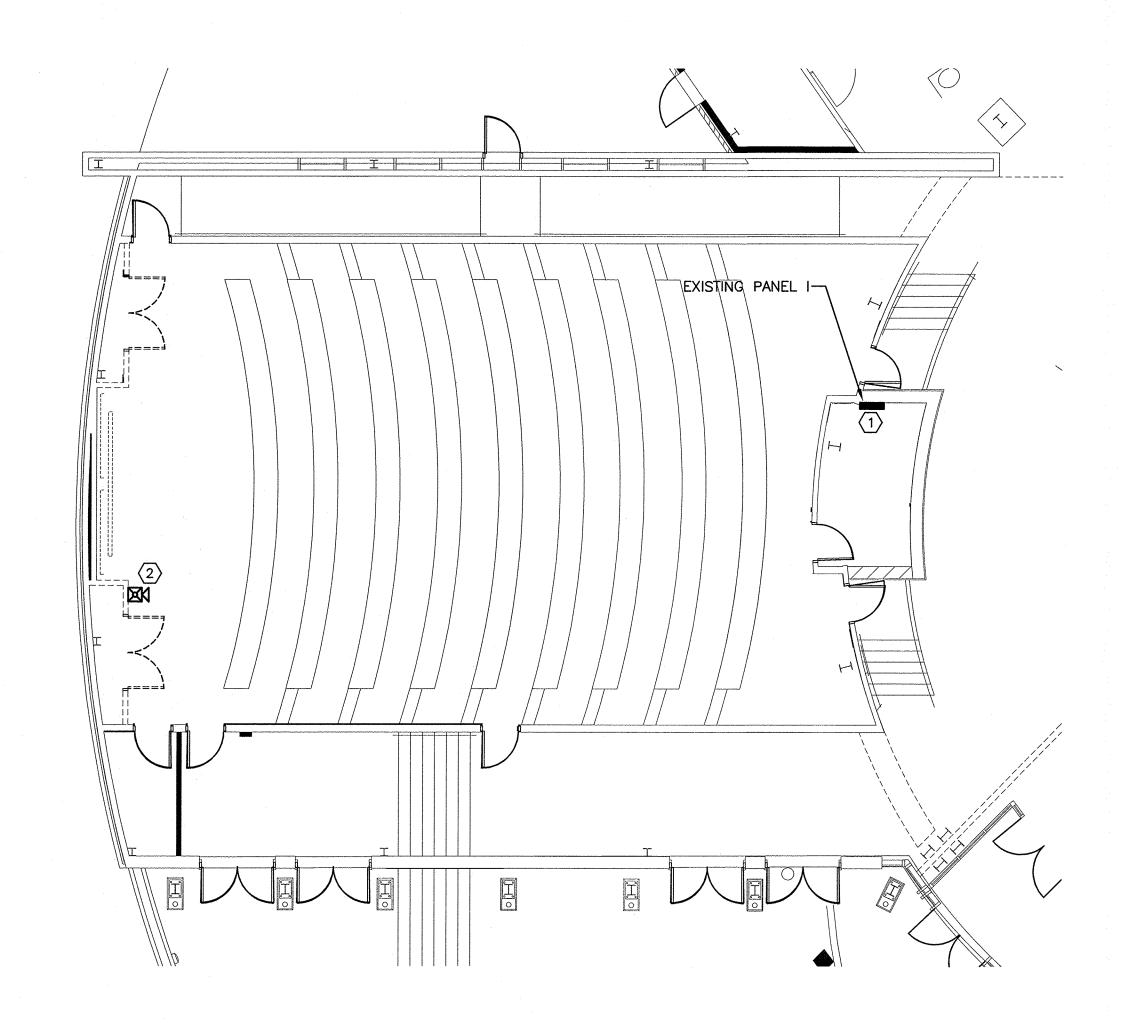

### EXECUTIVE AUDITORIUM DEMO WORK FLOOR PLAN - POWER Scale: 1/8" = 1'-0"

## EXECUTIVE AUDITORIUM NEW WORK FLOOR PLAN - POWER Scale: 1/8" = 1'-0"

#### **DEMO WORK KEYED NOTES:**

- REMOVE EXISTING SHEET METAL SKIRT AND EXISTING 42 CIRCUIT PANEL 'I'. EXISTING BRANCH CIRCUIT CONDUITS SERVED FROM THIS PANEL ARE TO BE REMOVED ENOUGH TO FACILITATE DEMOLITION OF THIS PANEL CAN AND INTERIOR.
- 2 REMOVE EXISTING FIRE ALARM COMBINATION HORN & STROBE DEVICE TO BE RELOCATED.

	ELECTRICAL DEVICES AND	INFRASTRUCTU	RE LEGEND
SYMBOL	DESCRIPTION	MOUNTING HEIGHT	INFRASTRUCTURE PROVISIONS
<b>©</b>	DIRECT WIRED EQUIPMENT ELECTRICAL CONNECTION	COORDINATE WITH EQUIPMENT	3/4"C FROM SOURCE TO DEVICE
Hood AV2	RECESSED 2-GANG JUNCTION BOX (FOR *VIDEO WALL)	9' AFF TO CENTER OF BOX	1 1/4"C IN WALL STUBBED ABOVE ACCESSIBLE CEILING
<b>ю</b> С	RECESSED 2-GANG JUNCTION BOX (FOR *CAMERA)	6'-9" AFF TO CENTER OF BOX	1 1/4"C IN WALL STUBBED ABOVE ACCESSIBLE CEILING
⊷ <sub>KP2</sub>	RECESSED CRESTRON BACK BOX (FURNISHED BY AV CONTRACTOR, INSTALLED BY DIV 26)	4'-3" AFF TO CENTER OF BOX	1 1/4"C FROM SOURCE TO DEVICE
Ю <sub>S</sub>	RECESSED 2—GANG JUNCTION BOX (FOR *SPEAKER CLUSTER)	12'-10" AFF TO CENTER OF BOX	1 1/4"C IN WALL STUBBED ABOVE ACCESSIBLE CEILING
⊷ WP4	RECESSED 4—GANG JUNCTION BOX (FOR *AV WALL PLATE)	1'-6" AFF TO CENTER OF BOX	1 1/4"C IN WALL STUBBED ABOVE ACCESSIBLE CEILING
ER6 PPPPP	SURFACE MOUNTED 12"x12" JUNCTION BOX (PROVIDED BY DIV 26). DUPLEX RECEPTACLES AND 8—PORT DATA OUTLET RECESSED IN JUNCTION BOX.	6'-4" AFF TO CENTER OF JUNCTION BOX. RECEPTACLE AND DATA OUTLET RECESSED IN TOP OF BOX.	PROVIDE (1) 3/4"C FROM SOURCE TO SERVE RECEPTACLES. PROVIDE 2"C FROM ABOVE ACCESSIBLE CEILING TO DATA OUTLET. PROVIDE 1 1/4"C TO AV BACK BOX.
►x	STANDARD FLUSH MOUNT DATA OUTLET IN 2-GANG BACK BOX. 'X' SUBSCRIPT INDICATES NUMBER OF DATA PORTS. NO SUBSCRIPT INDICATES 2 PORT DATA OUTLET.	1'-6" AFF TO CENTER OF BOX	1 1/4"C IN WALL STUBBED ABOVE ACCESSIBLE CEILING. PROVIDE (2) CAT6A CABLES FROM IDF ROOM TO DATA OUTLETS.

PAV2 PAV2 PAPOC KP2

### **KEYED NOTES:**

1 PROVIDE NEW 54 CIRCUIT PANEL 'I' WITH SHEET METAL SKIRT. COORDINATE INSTALLATION OF PANEL CAN AND INTERIOR WITH EXISTING PANEL 'I' FEEDER TO VERIFY LENGTH OF FEEDER IS LONG ENOUGH TO CONNECT TO THE NEW PANEL LUCS

-EXISTING DIMMING CONTROL PANEL

-EXISTING LIGHTING CONTROL PANEL

-EXISTING PANEL HI

-EXISTING LIGHTING CONTROL PANEL R2

RELOCATED FIRE ALARM COMBINATION HORN AND STROBE DEVICE. COORDINATE FIRE ALARM SHUTDOWN WITH OWNER PRIOR TO WORK TO ENSURE MINIMAL INTERRUPTION OF MONITORING.

### Dewberry\*

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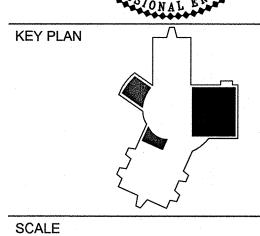
SEAL

WILLIAM A.

KEMP

Lic. No. 054535

3/15/19



As indicated

1 Schem / Design Dev Submission 07.01.18
No. Description Date

REVISIONS

REVISIONS

DRAWN BY

APPROVED BY
CHECKED BY

DATE JANUARY 15, 2019
TITLE

EXECUTIVE AUDITORIUM POWER PLANS

DEB Project Code # 885-18321-000
PROJECT NO. 50

E3.02

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Ö

		TRA SERIES PANEL CAT # RCUIT BREAKER							N	I.L.O.			KER I 0 A.I.	NTERRUI C	T RAT	ING:		3 Ф - 4 WIRI DEMAND AMPS:	3 Φ - 4 WIRE - 120/208 VOLT DEMAND AMPS: 72 125 AMP I			
ONDUIT SIZE	WIRE SIZE	(GRAY IS EXISTING)	KVA ΑΦ	KVA ΒΦ	KVA СФ	CKT BKR		WWW.5338	LOAD	300000000000000000000000000000000000000	AD O	СКТ	07111	CKT BKR	KVA AФ	KVA ВФ	KVA СФ	(GRAY IS EXISTING)	WIRE	CONDU		
SIZE	SIZE	SERVING TELECOM BOARD	0.36	DO	CΨ	1P-20		NO 1	TYPE R	R		2	$\overline{}$	1P-20	0.36	bψ	CΨ	SERVING TELECOM BOARD	SIZE	SIZE		
		RECEPT 022	0.50	0.36		1P-20		3	R	R		4	$\overline{}$	1P-20	0.30	0.54	1 F	RECEPT 022	-			
		CRCU 022 IDU		0.50	2.81	2P-45	_	5	R	$\frac{n}{R}$		6		1P-20		0.34	1.92	UNLABELED				
		CINCUIVEZ IDO	2.81	]	2,01	25-43	H	7	R	R		8		1P-20	1.92		1.92	UNLABELED				
		FACP	2.01	0.25		1P-20		9	R	⊢ r R		10		1P-20	1.92	1.92	ı H	UNLABELED				
		CRCU 072 ODU	-	0.23	1.02	2P-20	<u> </u>	11	R	R		12	$\overline{}$	1P-20		1.32	1.92	UNLABELED				
		**************************************	1.02	]	1.02	25-20	灶	13	R	R		14	$\overline{}$	1P-20	0.20	]	1.92	TV IN HALL				
		UNLABELED	1.02	1.92		1P-20		15	R	R		16		1P-20	0.20	1.92	ı F	UNLABELED				
		UNLABELED	_	1.72	2.50	2P-30		17	R	R		18	)	1P-20		1.34	1.92	UNEABELED				
		Artist State Labor	2.50		2,30	21 30	士	19	R	R		20	<b>△</b>	2P-30	2.50	1	1.52	DATA CABINET				
		DATA CABINET	2.50	2.50		2P-30	1	21	R	R		22	$\pm$	21 30	2.30	2.50		208 RECEPT.				
+		208V RECEPT		2.30	2.50	2, 30	H	23	R	R		24	$\overline{}$	1P-20		2.30	1.92	LUMOS RECEPT				
3/4"	2#12	*AV RACK	1.92		2.30	1P-20	$\overline{}$	25	R		C. S. V. V. MAY	26	)	±) =0			1.52	SPACE				
-, ·		SPACE	-10-				7	27	• •		0000	28	)					SPACE				
		SPACE					$\overline{}$	29				30	)					SPACE				
			CONI	VECTE	) kVA	NEC DE	MAN	ID FA	CTOR	<u> </u>			ID (k	VA)	FEED	THRU	LUGS	FED FROM:	AΦ=	13.6 kV		
ONTINUO	OUS LOAD	os (c)	-	0.00			125					947X 9790	00							11.9 kV		
		LOADS (NC)		0.00			100	)%				0.	00		ΑФ	ВФ	СФ	DP3		16.5 kV		
	LES LOAD			42.01		10	KVA	+ 50%	6			26	.00	Ţ.					1A TOTAL			
	.OADS (K)			0.00			100	)%				0.	00									
ARGEST N	MOTOR (I	_M)		0.00		1259	6 <b>O</b> F 1	LARG	EST			0.	00					TOTALCON	NECTED =	42 kVA		
EVATOR	(FI)			0.00						0.	00					TOTALI	DEMAND =	26 kVA				

	NEW CI	RCUIT BREAKER						EX	(IST	A\$50,000,000				PORTOR PROPERTY AND PROPERTY.	DF				
<u>-PANEL IS</u>	A GE SPE	ECTRA SERIES ORDER #17	<u> /8PP87185</u>	<u>, DATE CO</u>	DE MM3	06		3P-80	OA MCB	BREA 42 O	AKER I 00 A.I.	NTERRU C	PT RAT	ING:		3 Φ - 4 WIRE - 120/208 VOLT DEMAND AMPS: 761 800 AMP B			
CONDUIT SIZE	WIRE SIZE	(GRAY IS EXISTING) SERVING		KVA KVA вф СФ	CKT BKR		CKT NO	LOAD TYPE	LOAD TYPE	CKT		CKT BKR	КVA AФ	AVANAMINA MARKATA MA	KVA CΦ	(GRAY IS EXISTING) SERVING		CONDUI SIZE	
		UNLABELED	21.62		3P-225	T	1	NC	Р	2	个	3P-200	19.04			*PNL G3	SEE	SEE	
			7	21.62		和	3	NC	Р	4	14			17.30			RISER	RISER	
				21.62		ス	5	NC	P	6	人				16.61				
		PNLL	18.50		3P-200	不	7	Р	NC	8	不	3P-225	2.05			DIMINIER PAL DR2			
			2	20.35		本	9	Р	NC	10	不			2.40					
				17.26		지	11	Р	NC	12	人				4.16				
		PNLI	9.60		3P-100	T	13	NC		14	~					SPACE			
				9.60		利	15	NC		16	~								
				9.60		지	17	NC		18									
		PNLG	5.04		3P-225	$\neg$	19	NC	NC	20	个	3P-225	21.62			PNL G1			
				5.65		4	21	NC	NC	22	体			21.62					
				4.07		지	23	NC	NC	24	人				21.62				
						$\overline{}$	25		NC	26	个	3P-400	5.95			DIMINING PNLDR1			
						$\overline{}$	27		NC	28	1			5.68		- (CENTER MOUNTED)			
							29		NC	30	1				8.46				
				CTED kva	NEC DE	<u>MAN</u>	D FA	CTOR	<u>D</u>	<u>EMAI</u>	ND (k	<u>(VA)</u>	FEED	THRU L	UGS	FED FROM:	ΑΦ=	103.4 kV	
CONTINU				0.00		125				20000000000	.00					DP3		104.2 kV	
		S LOADS (NC)		16.38	40	100					6.38		ΑФ	ВФ	СФ			103.4 kV	
RECEPTAC KITCHEN I				17.18 0.00	TUI	+ KVA 100	1 1 1 1 1 1 1 1 1 1 1 1 1 1 1 1 1 1 1	)			8.59 1.00					DP3 EXCLUDING FTL & SUB- G3 DR2 DR1 G J I G1-RIGHT			
LARGEST	9985667940 <b>5</b> 546698989866866			7.49	125%	2010/03/2018/2019		EST			1.36					TOTAL CON			
ELEVATOR	ALCOHOLOGY AND	,-,,,,		0.00	/	100	A	,			.00						EMAND =	SANSON STANSONS STANS	
		ARE INCLUDED IN THE CON																	
~~~~~~~~~~~~~~~~~~~~~~~~~~~~~~~~~~~~~~~		TION IN THE PANEL DIRECT	······································	<del></del>	······································				<del></del>										
NOTE TO	REVIEWER	R: LOADS FROM EXISTING S	UB-FED PA	NELS WERE	OBTAINE	ED VIA	A AS-E	BUILTS	OR BY IN	CLUDI	ING 8	0% OF TI	HE FEED	DER BRE	AKER C	CAPACITY.			


PANEL N		UIT CONNECTED TO NEW BR	FAKER	<u> </u>							N	IE)	N	PA	M	EL				
LMOTH	· · · · · ·	ON CONNECTED TO NEW DI	CLARCE	`					M.	L.C			KER	INTERRU			-	3 Φ - 4 WIRE - DEMAND AMPS: 111		VOLT
CONDUIT SIZE	WIRE SIZE	SERVING	KVA AФ	KVA вФ	KVA CΦ	CKT BKR		CKT NO	LOAD TYPE		LOAD TYPE	СКТ		CKT BKR	KVA AФ	KVA ВФ	KVA СФ	SERVING		CONDI
		**AIR CONDITIONING	3.74			2P-45	$\uparrow$	1	LM	$\blacksquare$	R	2	(	1P-20	0.54			**TEACHER RECEPT.		
				3.74			ᄉ	3	LM		R	4	(	1P-20		0.54		**TEACHER RECEPT.		
		**STORAGE RECEPT.			0.18	1P-20	$\overline{}$	5	R		R	6	(	1P-20			0.54	**TEACHER RECEPT.		
		**AUDIT. COMP. RECEPT.	1,44			1P-20	$\overline{}$	7	R		R	8	(	1P-20	1.44			**AUDIT. COMP. RECEPT.		
		**AUDIT. COMP. RECEPT.		1.44		1P-20	(	9	R		R	10	)	1P-20		1.44		**AUDIT. COMP. RECEPT.		
		**AUDIT. COMP. RECEPT.			1.44	1P-20	$\overline{}$	11	R		R	12	(	1P-20			1.44	**AUDIT. COMP. RECEPT.		
		**AUDIT. COMP. RECEPT.	1.44			1P-20	$\overline{}$	13	R		R	14	(	1P-20	1.44			**AUDIT. COMP. RECEPT.		
		**AUDIT. COMP. RECEPT.		1.44		1P-20	$\overline{}$	15	R		R	16	(	1P-20		1.44		**AUDIT. COMP. RECEPT.		
		**AUDIT. COMP. RECEPT.			1.44	1P-20	$\overline{}$	17	R	Γ	R	18	(	1P-20			1.44	**AUDIT. COMP. RECEPT.		
		**AUDIT. COMP. RECEPT.	1.44			1P-20	$\overline{}$	19	R		R	20	(	1P-20	1.44			**AUDIT. COMP. RECEPT.		
		**AUDIT. COMP. RECEPT.		1.44		1P-20	$\sim$	21	R	T	R	22	(	1P-20		1.44		**AUDIT. COMP. RECEPT.		
		**AUDIT. COMP. RECEPT.			1.44	1P-20	~	23	R		R	24		1P-20			1.44	**AUDIT. COMP. RECEPT.		
		**AUDIT. COMP. RECEPT.	1.44			1P-20	$\overline{}$	25	R		R	26		1P-20	1.44			**AUDIT. COMP. RECEPT.		
		**AUDIT. COMP. RECEPT.		1.44		1P-20	$\sim$	27	R		R	28	$\overline{}$	1P-20		1.44		**AUDIT. COMP. RECEPT.		
		**AUDIT. COMP. RECEPT.			1.44	1P-20	$\sim$	29	R	T	R	30	$\overline{}$	1P-20		1	1.44	**AUDIT. COMP. RECEPT.		
		**AUDIT. COMP. RECEPT.	1.44			1P-20	$\sim$	31	R		R	32	$\overline{}$	1P-20	0.72			**RECEPT. CORR. 016		
		**AUDIT. COMP. RECEPT.		1.44		1P-20	$\sim$	33	R	Ī	R	34	~	1P-20		0.72		**RECEPT. CORR. 019		
		**AUDIT. COMP. RECEPT.			1.44	1P-20	$\sim$	35	R		R	36	~	1P-20			1.92	**SOUND RACK		
		**SPARE				1P-20	$\overline{}$	37			R	38	$\overline{}$	1P-20	0.54			**RECEPT. PROJ. BOOTH		
		**LOBBY RECEPTACLES		0.72		1P-20	$\sim$	39	R		R	40	$\sim$	1P-20		1.66		**PROJECTOR 208V		
		**SPARE	,			1P-20	$\overline{}$	41		Ť	R	42	~	1P-20			1.66			
3/4"	2#12	LED TV VIDEO WALL	1.76			1P-20	$\overline{A}$	43	R	T	R	44	$\overline{}$	1P-20	1.38			AV RACK RECEPTS.		
3/4"	2#12	LED TV VIDEO WALL		1.76		1P-20	$\overline{A}$	45	R	1	R	46	~~	1P-20		1.38		AV RACK RECEPTS.		
		SPARE	1			1P-20	$\supset$	47		T		48	$\overline{}$	1P-20				SPARE		
		SPARE				1P-20	=	49		H		50	$\overline{}$	1P-20				SPARE		
		SPARE				1P-20	$\supset$	51		F		52	$\overline{}$	1P-20				SPARE		
		SPARE				1P-20	$\rightarrow$	53		ð		54	<u>~</u>	1P-20				SPARE		
		3) AIL	CONV	JECTE	D KVA	NEC DE	MAN	A COLUMN TOWN	CTOR		nı	MAN	JD (k	100000	FEFD	THRU	HIGS	FED FROM:	ΔΦ-	18.5 kV
CONTINU	OUS LO	ADS (C)		0.00	<del>- 11 1/1</del>		125	TO THE OWNER OF THE OWNER OWNER OF THE OWNER O	<u>91911</u>		=	Control of the Contro	.00		LLLU	I	1003			20.3 kV
		JS LOADS (NC)		0.00			1009	%					.00		ΑФ	ВФ	СФ	DP3		17.3 kV
RECEPTAG		•		51.25		10	KVA+	#225 COM-5	6				).63						TOTAL	56.1 kV
RECEPTAG				0.00			1009						.00							
ARGEST		(LM)		7.49		125%			EST			9.	.36		200723000	100°04,500°0450,0°044	- 	TOTAL CONN	ECTED =	56 kVA
LEVATO				0.00			1009	1000				0.	.00					TO <b>T</b> AL DE	MAND =	40 kVA
		S ARE INCLUDED IN THE CONNE	945-040-05-040-05-05-05-05-05-05-05-05-05-05-05-05-05	V 0004047 ARE A CEAN																
		PTION IN THE PANEL DIRECTOR												RCUIT TO	BE DIS	TINGU	ISHABL	E FROM ALL OTHERS.		
THE PANE	LSHALL	BE MARKED TO INDICATE THE D	DEVICE	OR EQ	UIPME	NT WHEF	RETHE	POV	VER SUP	PLY	YORIG	INAT	ES.			en de particular de la companyación de la companyac	*****************************			
THE PANE	LSHALL	BE LEGIBLY MARKED WITH THE	MAXIN	'A MUN	VAILAB	LE FAULT	CURF	RENT,	, INCLUE	NIC	IG THE	DATE	THE	CALCULA	NOIT	WAS PI	ERFORM	ΛED.		


	E NEW C	IRCUIT BREAKER						E)	(IST	'IN	lG	P/	M	EL	CF			
PANEL IS	A GE SP	ECTRA SERIES ORDER #						N	1.L.O.		AKER   00 A.I	NTERRU	PTRAT	ING:		3 Φ - 4 WIRE - DEMAND AMPS: 139		VOLT AMP BU:
CONDUIT	WIRE	(GRAY IS EXISTING)	KVA KV	A KVA	CKT	e de la companya de	СКТ	LOAD	LOAD		T T	CKT	KVA	KVA	KVA	(GRAY IS EXISTING)	WIRE	
SIZE	SIZE	SERVING	AO BO	СФ	BKR		NO	TYPE	TYPE	NO		BKR	ΑФ	ВФ	СФ	SERVING	SIZE	SIZE
		CONF. TABLE RECEPT.	1.26		1P-20		1	LM	R	2	-	1P-20	1.26			CONF. TABLE RECEPT.		
		CONF. TABLE RECEPT.	1.2	6	1P-20	^	3	LM	R	4	~	1P-20		1.26		CONF. TABLE RECEPT.		
		CONF. TABLE RECEPT.		1.26	1P-20	_	5	R	R	6	~	1P-20			1.26	CONF. TABLE RECEPT		
		CONE, TABLE RECEPT.	1.26		1P-20	$\sim$	7	R	R	8	$\vdash$	1P-20	1.26			CONF. TABLE RECEPT.		
		FLOOR BOX RECEPT	0.7	2	1P-20		9	R	R	10		1P-20		0.72		FLOOR BOX RECEPTACLES		
		FLOOR BOX RECEPT		0.54	1P-20		11	R	R	12	ໄス	1P-20		-	0.54	A/V RECEPT.		
		COMPUTERS	1.08	-	1P-20	$\sim$	13	R	R	14		1P-20	1.50		0.31	A/V RACK		
		A/V RECEPTACLES	0.7	2	1P-20		15	R	R	16		1P-20	1.00	1.50		A/V RACK		
		PLASMA SCREEN	- 10.7	1.08	4		17	R	R	18		1P-20		1.50	0.66	LED TV VIDEO WALL	2#12	3/4"
		PLASMA SCREEN	1.08	1.00	1P-20		19	R	1 1 1	20		3P-15		1	0.00		2#12	3/4
		A/V PROJECTOR	0.5	<u></u>	1P-20	<del></del>	21	R		22	壯	2L-12				SPARE		
		SPACE		U	1F-20			LV.	l		H							
				<u> </u>	40.00		23			24		l		1				
		SPARE			1P-20	<del></del>	25		NC.	26		2P-20	1.25		1	CONDENSATION PUMP		
		SPARE			1P-20		27		NC NC	28				1.25				
		SPARE			1P-20	-	29		R	30		1P-20		1	1.32	LED TV VIDEO WALL	2#12	3/4"
		CONDENSING UNIT	3.36		3P-40	$\Box$	31	NC	LM	32		3P-50	4.20		1	AHU		
			3.3	6			33	NC	LM	34				4.20		14 - 14 - 14 - 14 - 14 - 14 - 14 - 14 -		
				3.36			35	NC	LM	36	人				4.20			
3/4"	2#12	*TV RECEPTACLES	0.56		1P-20		37	R	R	38	_	1P-20	1.39			*CONF. RM A/V RACK	2#12	3/4"
		SPACE				~	39		R	40		1P-20		1.39		*CONF. RM A/V RACK	2#12	3/4"
		UNLABELED		1.92	1P-20	$\overline{}$	41	R	R	42	$\sim$	1P-20			1.92	UNLABELED		
			CONNECT	ED kVA	NEC DE	MAN	ND FA	CTOR	D	ЕМА	ND (k	(VA)	FEED	THRU	LUGS	FED FROM:	ΑФ=	19.5 kV/
	OUS LOA		0.0	0		125	5%		7	C	.00					DD4		16.9 kV
		IS LOADS (NC)	12.5			100				1	2.58		ΑФ	ВФ	СФ	DP4	СФ=	18.1 kV
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		ARE INCLUDED IN THE CONI			CALCUI			-			.00		<u> </u>			TOTAL DE	= UNANI	<b>DU KVA</b>
		TION IN THE PANEL DIRECTO						DETAIL	L TO ALLO	W EA	CHCI	RCUIT TO	BE DIS	TINGU	ISHABL	E FROM ALL OTHERS.		

### Dewberry\*

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As indicated

SCALE

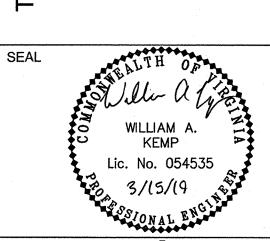
1 | Schem / Design Dev Submission | 07.01.18 **REVISIONS** 

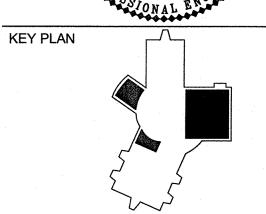DRAWN BY APPROVED BY WAK CHECKED BY DATE JANUARY 15, 2019 TITLE

PANEL SCHEDULES

DEB Project Code # 885-18321-000 PROJECT NO. 50100160

E4.00

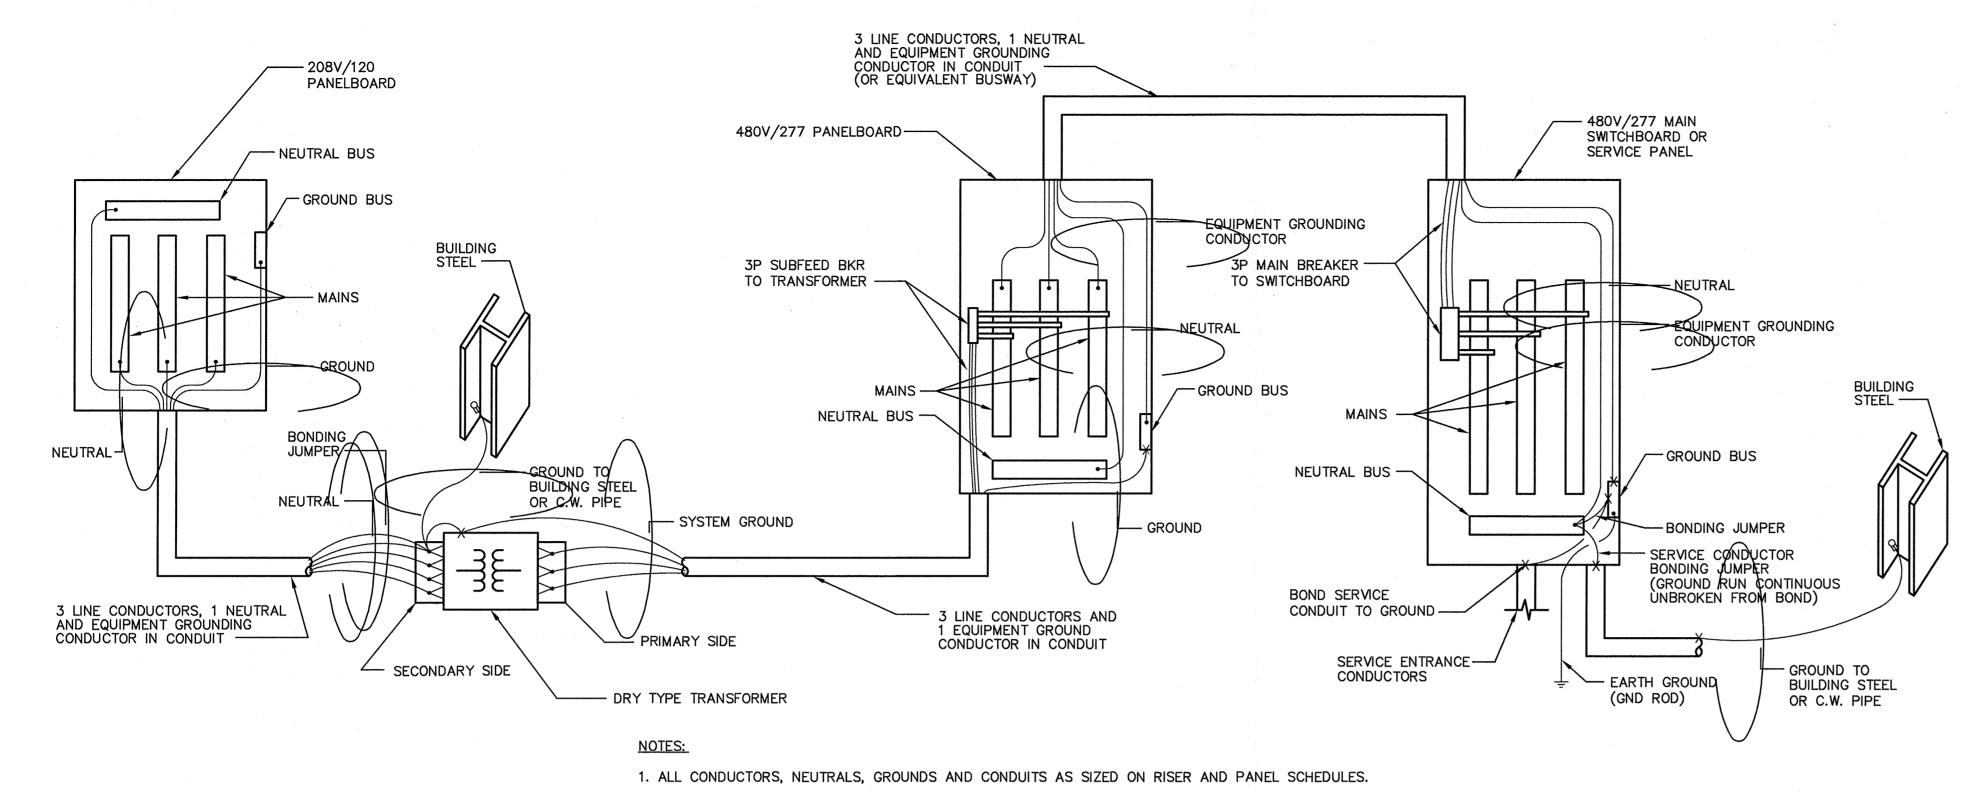


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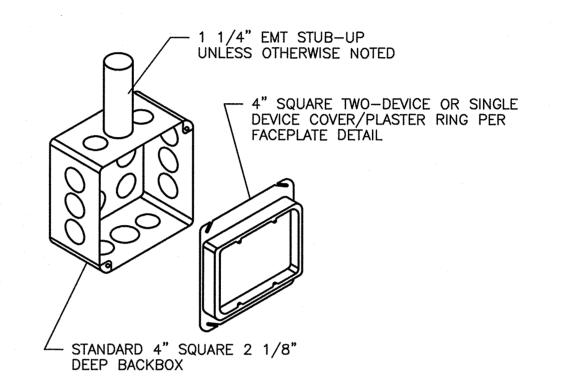
O

2. SYSTEM GROUND CONDUCTOR SHALL BE CONTINUOUS (UNBROKEN) AND SHALL BE RUN DIRECTLY FROM CONNECTION.



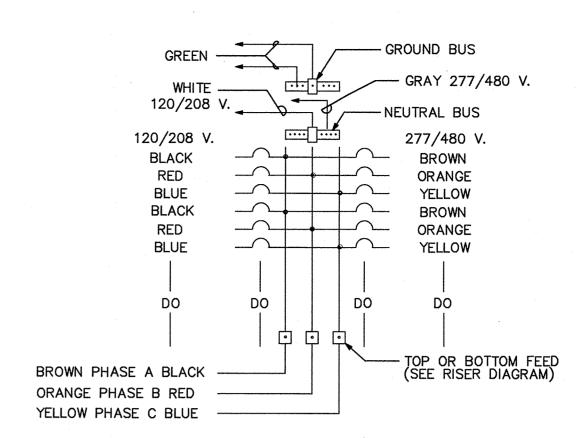

WIRE COLOR CODING NOT TO SCALE E5.00




AV BOX DETAIL E5.00 NOT TO SCALE

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THE INSTITUTE SEAL KEMP **KEY PLAN** 



SCALE

As indicated

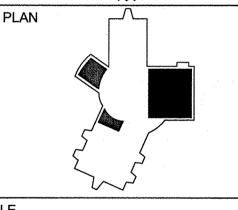1 Schem / Design Dev Submission 07.01.18


No. Description Date **REVISIONS** DRAWN BY

WAK APPROVED B CHECKED BY DATE JANUARY 15, 2019 TITLE


**ELECTRICAL DETAILS** 

DEB Project Code # 885-18321-000 PROJECT NO. 50100160

E5.00

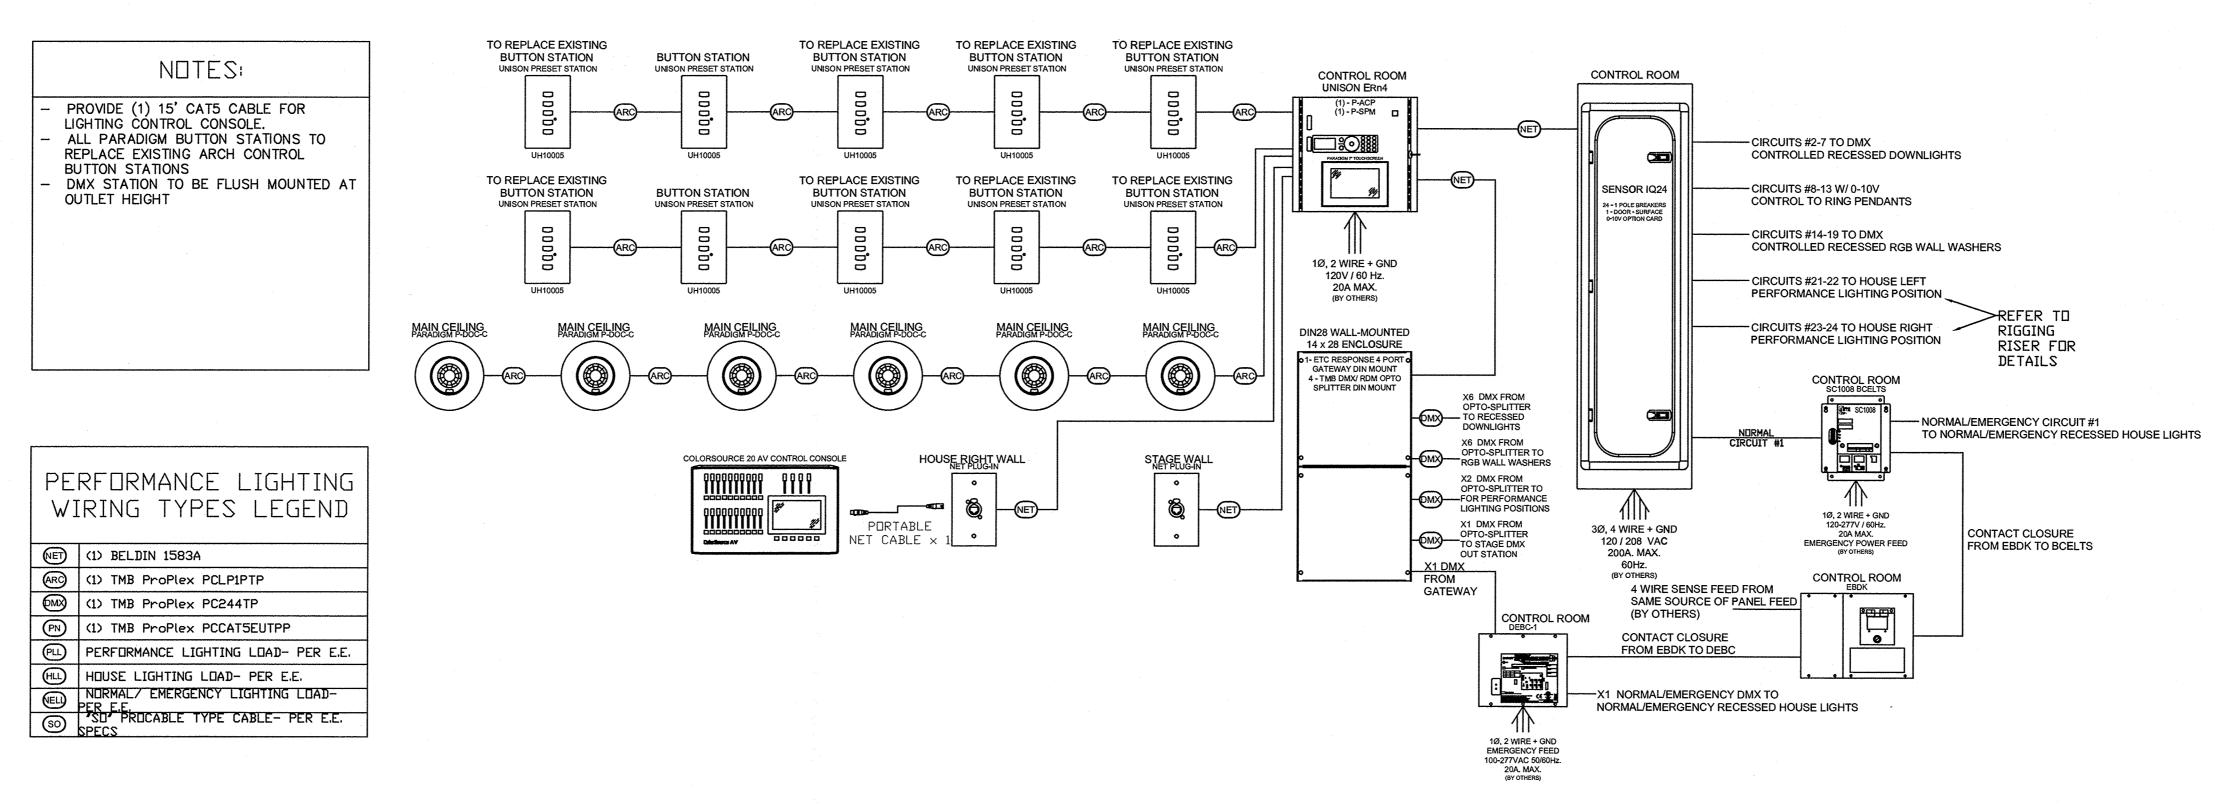

GREAT HALL LIGHTING CONTROL DIAGRAM E5.01 NOT TO SCALE

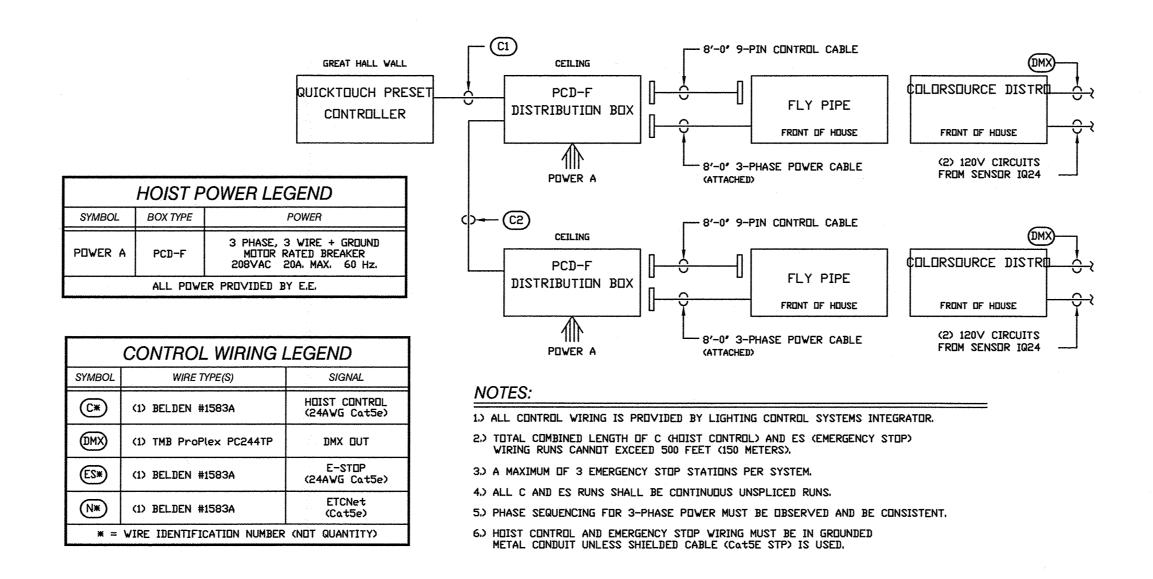


GREAT HALL RIGGING RISER E5.01 NOT TO SCALE

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ADVANCED LEARNING CONFERENCE FACILITY IMPROVEMENTS

SEAL WILLIAM A.



KEMP
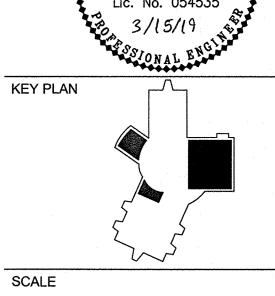
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DATE JANUARY 15, 2019 TITLE

**GREAT HALL** 

LIGHTING **DIAGRAMS** 

DEB Project Code # 885-18321-000 PROJECT NO. 50100160

E5.01

SHEET NO.

O



### IALR 150 SLAYON AV DANVILLE, VA 24540

## AUDIOVISUAL SYSTEMS DRAWINGS

	DRAWING INDEX		
		0	
		/IEW	COORDINATION
		ISSUE FOR REVIEW	
		SSUEF	Q
			ISSNE
		8	
		10/25/2018	1/8/2019
		10/2	$\frac{1}{8}$
TA00-000	AUDIOVISUAL DRAWING INDEX	0	1
TA00-001	AUDIOVISUAL NOTES AND RESONSIBILTIES	0	
TA01-101	GREAT HALL - AUDIOVISUAL FLOOR FACILITIES PLANS	0	
TA01-111	GREAT HALL - AUDIOVISUAL CEILING FACILITIES PLANS	0	
TA01-131	GREAT HALL - SALON A & B - AUDIOVISUAL SCREEN EQUIPMENT ELEVATION	0	
TA01-132	GREAT HALL - SALON A & B - AUDIOVISUAL SCREEN ELECTRICAL ELEVATION	0	1
TA01-133	GREAT HALL - SALON A & C - AUDIOVISUAL DISPLAY ELEVATIONS	0	1
TA01-134	GREAT HALL - SALON E & F - AUDIOVISUAL DISPLAY ELEVATIONS		1
TA01-135	GREAT HALL - SALON B & D - AUDIOVISUAL DISPLAY ELEVATIONS		1
TA01-201	GREAT HALL - AUDIOVISUAL FLOOR ELECTRICAL PLANS	0	1
TA01-211	GREAT HALL - AUDIOVISUAL CEILING ELECTRICAL PLANS	0	1
TA01-231	GREAT HALL - AUDIOVISUAL RISER DIAGRAMS	0	1
TA01-232	GREAT HALL - AUDIOVISUAL RISER DIAGRAMS		1
TA02-101	AUDITORIUM - AUDIOVISUAL FACILITIES PLANS	0	1
TA02-131	AUDITORIUM - AUDIOVISUAL VIDEO WALL ELEVATION	0	1
TA02-201	AUDITORIUM - AUDIOVISUAL ELECTRICAL PLANS	0	1
TA02-231	AUDITORIUM - AUDIOVISUAL RISER DIAGRAMS	0	1
TA03-101	EXECUTIVE BOARDROOM - AUDIOVISUAL FACILITIES PLANS	0	
TA03-131	EXECUTIVE BOARDROOM - AUDIOVISUAL VIDEO WALL ELEVATION	0	1
TA03-201	EXECUTIVE BOARDROOM - AUDIOVISUAL ELECTRICAL PLANS	0	1
TA03-231	EXECUTIVE BOARDROOM - AUDIOVISUAL RISER DIAGRAMS	0	



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1 01/08/2019 SSUE FOR COORDINATION DESCRIPTION

DATE: 10/25/2018 SCALE: AS NOTED DRAWN: B.HOAGE ENG BY: S. O'DONNELL


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IALR COVER PAGE AND INDEX

TA00-000

L06877

L06877 TA00-000 Audiovisual Cover & Index.dwg

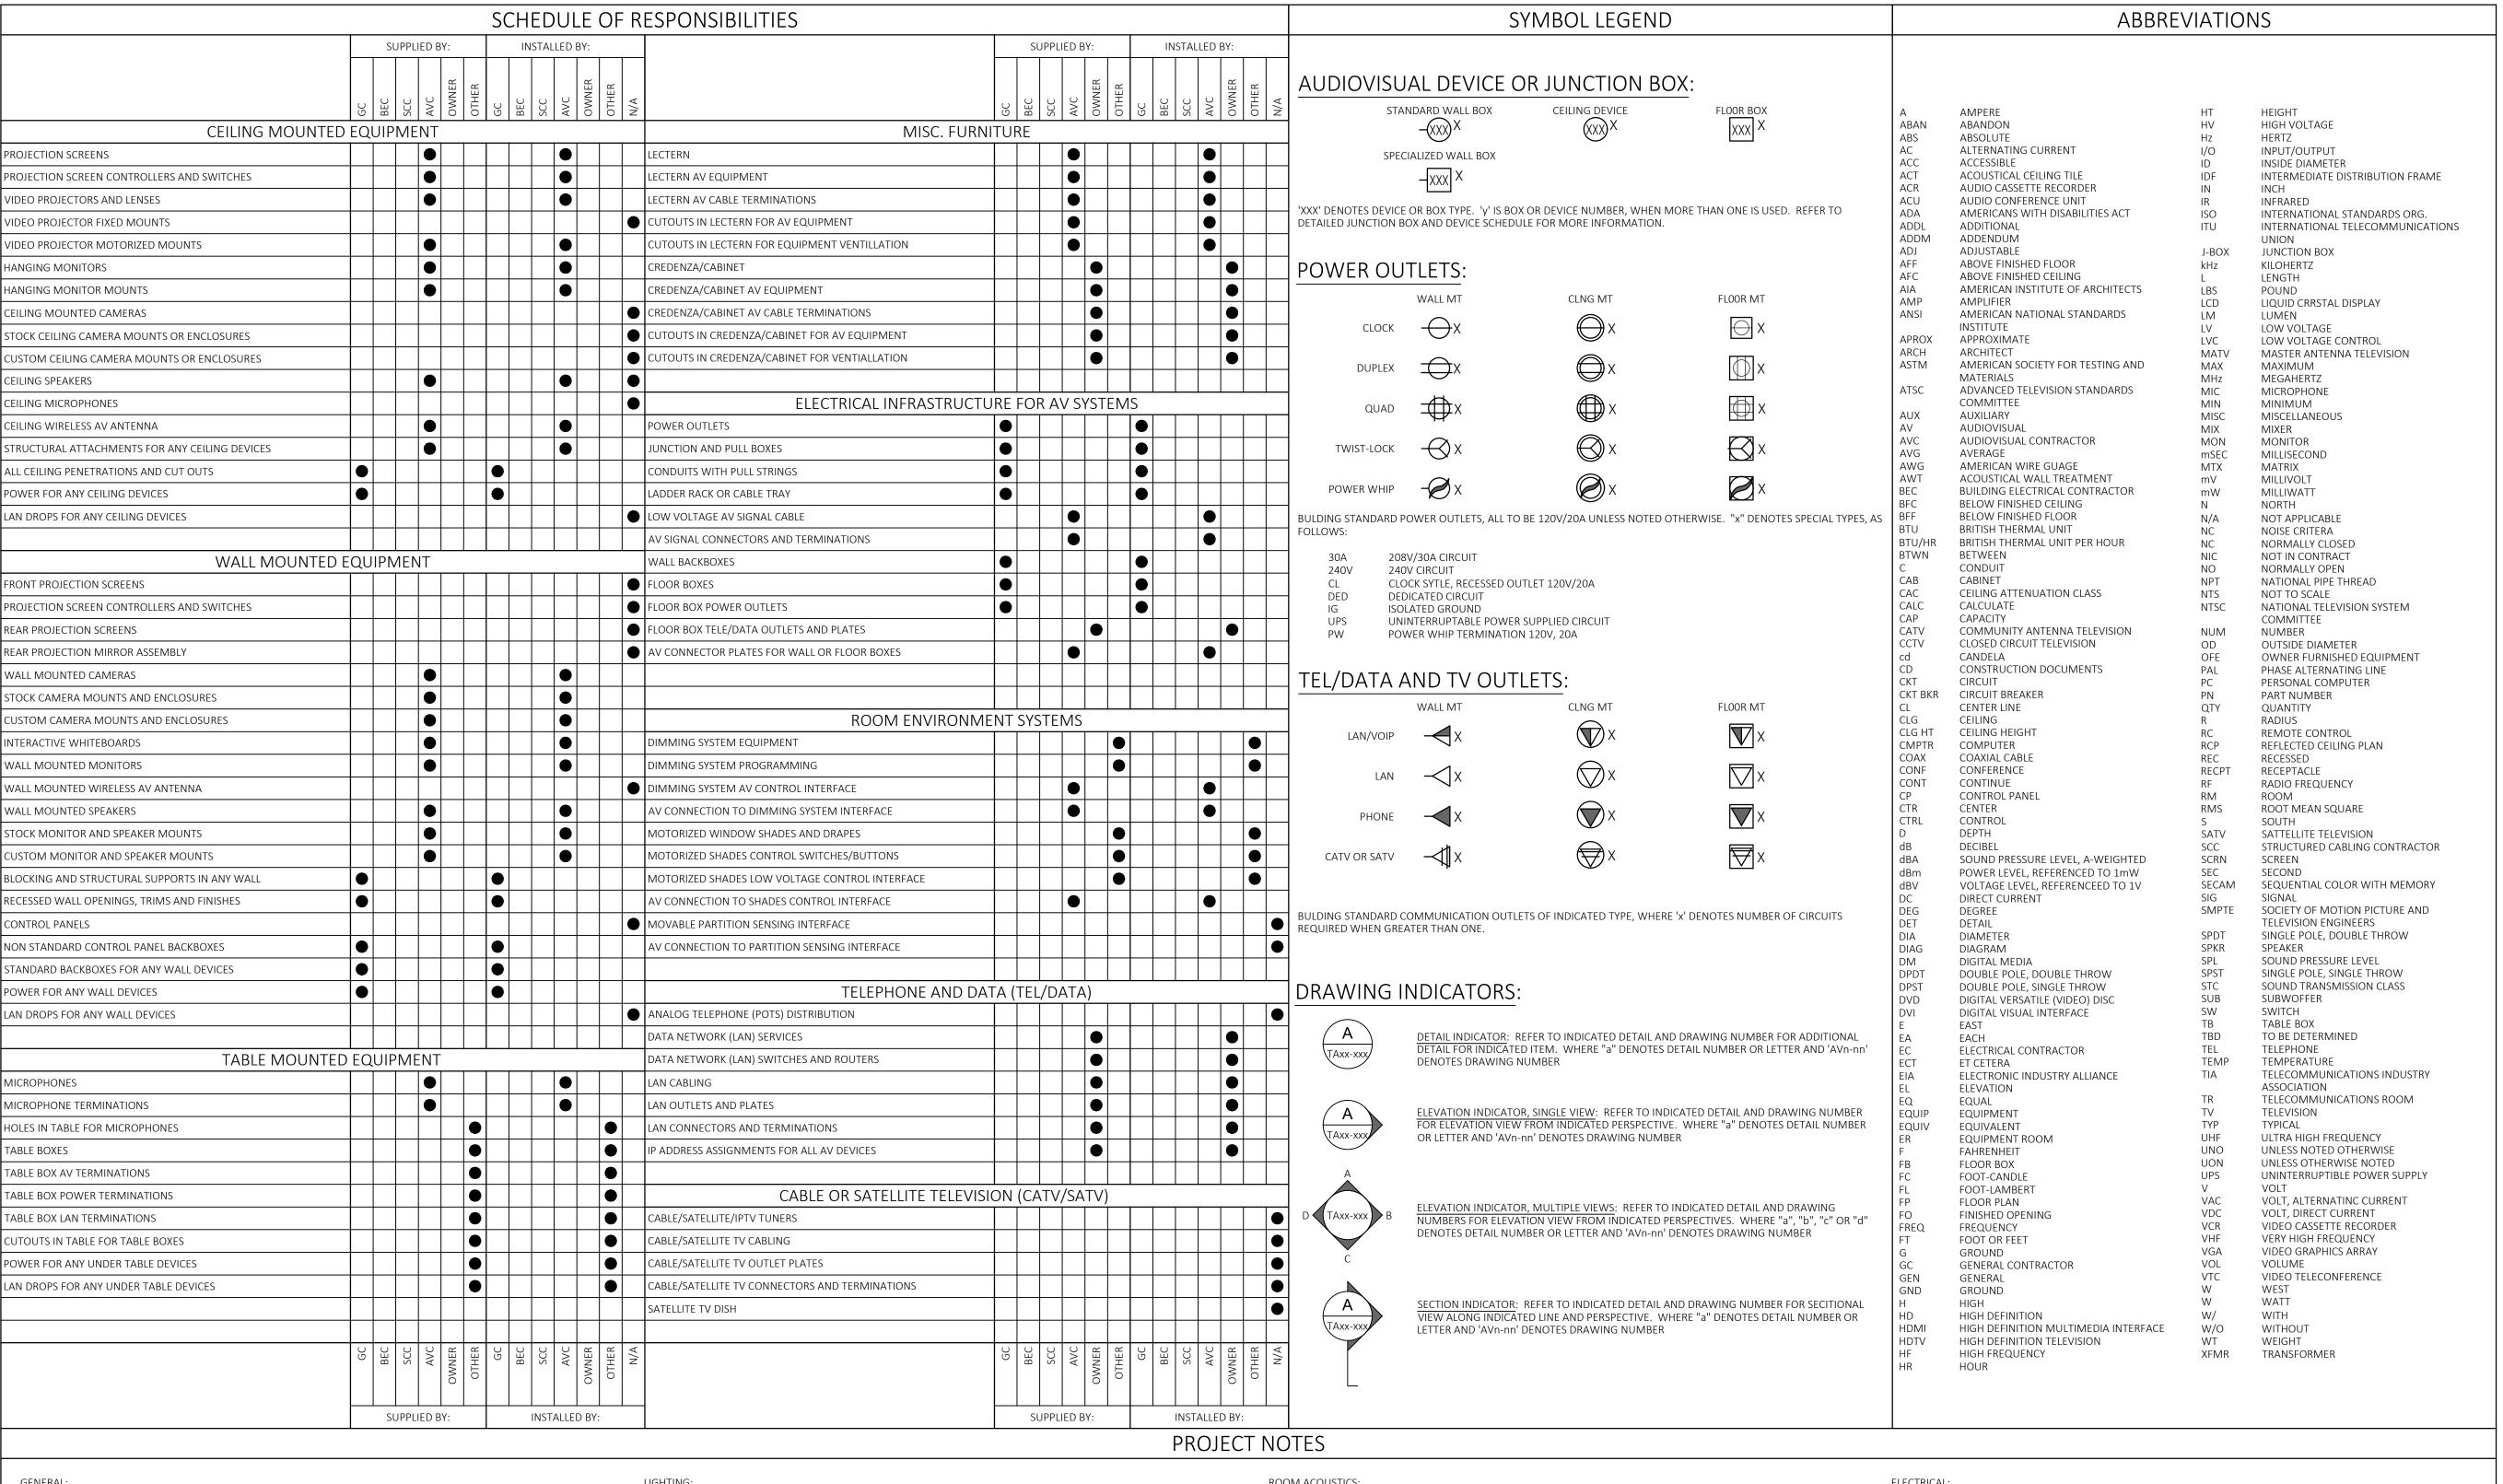

- .. THESE DRAWINGS PROVIDE ADVICE AND INFORMATION TO THE PROJECT OWNER, ARCHITECT AND ENGINEERS. THESE DRAWINGS ARE NOT INTENDED AS CONSTRUCTION DOCUMENTS, AND SHOULD NOT BE USED AS SUCH. ONCE ACCEPTED BY THE PROJECT OWNER, THE INFORMATION INCLUDED IN THESE DRAWINGS SHOULD BE INCORPORATED INTO THE PROJECT CONSTRUCTION DOCUMENTS AS ISSUED BY THE ARCHITECT AND/OR ENGINEERS.
- ANY DISCREPANCIES BETWEEN THESE DOCUMENTS AND CONSTRUCTION DOCUMENTS ARE TO BE REFERRED TO THE ARCHITECT FOR RESOLUTION.
- 3. THE FINAL LOCATION OF ALL INDICATED DEVICES SHALL BE COORDINATED BY THE ARCHITECT.

- .. THE CABINETS CONTAINING AUDIOVISUAL EQUIPMENT MUST PROVIDE FOR THE CIRCULATION OF AIR TO REMOVE HEAT GENERATED BY AV EQUIPMENT. VENTS MUST BE PROVIDED AT FRONT/BOTTOM AND TOP/REAR OF CABINET. FAILURE TO DO SO MAY RESULT IN DAMAGE TO THE AUDIOVISUAL EQUIPMENT.
- THE DOORS ON THE SECTIONS CONTAINING THE EQUIPMENT RACKS MUST BE REMOVABLE OR HINGED TO PERMIT 180° SWING TO ALLOW FOR SERVICING OF THE EQUIPMENT.

- THE TOTAL NUMBER OF CONTROLLABLE ZONES IS DEPENDENT UPON ROOM SIZE AND FUNCTION. REFER TO AV REFLECTED CEILING DRAWINGS FOR SUGGESTED LIGHTING ZONES.
- LIGHT ON DISPLAYS OR SCREENS MUST BE LESS THAN 15 FC. ANY FIXTURE THAT CASTS DIRECT LIGHT ON A DISPLAY OR SCREEN MUST BE PLACED IN AN INDEPENDENT ZONE.
- INDIRECT FLORESCENT LIGHTING FIXTURES, CAPABLE OF PROVIDING EVEN ILLUMINATION WITHOUT SHADOWS, ARE SUGGESTED IN ROOMS WITHOUT VIDEO TELECONFERENCING.
- 4. FIXTURES WITH LOUVERED DIFFUSERS ANGLED AT 45°, AIMED FROM ABOVE THE CAMERA TOWARD THE PARTICIPANTS, ARE SUGGESTED IN ROOMS WITH VIDEO TELECONFERENCING.
- 5. LIGHT LEVELS AT PARTICIPANTS: 40-50 FC, 1.5:1 MAX:MIN UNIFORMITY ACROSS ALL FACES.
- LIGHT LEVELS AT WALLS: 15-20 FC, 1.5:1 MAX:MIN UNIFORMITY RATIO ACROSS WALL SURFACES BEHIND PARTICIPANTS FROM TABLE TOP HEIGHT TO 24" ABOVE EYE HEIGHT OR 6'
- 7. LAMPS: 3000-3500K CORRELATED COLOR TEMPERATURE, 85 COLOR RENDERING INDEX (CRI)
- DIMMING SYSTEMS SHOULD BE OUTFITTED WITH LOW VOLTAGE CONTROLLERS FOR INTERFACING WITH THE AUDIOVISUAL CONTROL SYSTEM.

- LIGHT THROUGH EXTERIOR OR INTERIOR WINDOWS MAY CAUSE ISSUES IN ROOMS WITH VIDEO TELECONFERENCING BY ALLOWING A "MIX" OF LIGHTING COLOR TEMPERATURES.
- BLACKOUT SHADES ARE REQUIRED ON ALL WINDOWS IN ROOMS WITH VIDEO TELECONFERENCING, AND ON ALL EXTERIOR WINDOWS IN ANY ROOM WITH A DISPLAY OR SCREEN. IT IS RECOMMENDED THAT THESE SHADES BE MOTORIZED, WITH LOW VOLTAGE CONTROL INTERFACES.
- TO THE FULLEST EXTENT POSSIBLE ALL FINISHES IN VIDEO TELECONFERENCE ROOMS SHOULD BE OF A NEUTRAL COLOR, LIGHT GRAY TO LIGHT BLUE IS RECOMMENDED.

- 1. ROOM AMBIENT NOISE NOT TO EXCEED 40dB A-WEIGHTED.
- 2. AN NC-30 NOISE CRITERIA RATING SHOULD BE MAINTAINED.
- 3. MAXIMUM REVERBERATION TIME SHOULD NOT EXCEED 600mS FOR ALL ROOMS.
- ACOUSTICAL PANELS OR "SOUND-SOAK" WALL TREATMENTS SHOULD BE CONSIDERED FOR AT LEAST 75% OF WALL SURFACES, IN AN ASYMMETRICAL PATTERN.
- 5. ACOUSTICAL PROPERTIES OF THE CEILING TILES, CARPET AND CARPET PAD SHOULD BE CONSIDERED DURING
- 6. TO PREVENT SOUND LEAKAGE INTO THESE ROOMS FROM ADJOINING SPACES, ALL WALLS SHOULD EXTEND TO THE DECKING ABOVE. ALL PENETRATIONS LEAVING THE SPACE SHOULD BE SEALED AS REQUIRED. THE SPACE ABOVE THE CEILING TILES MAY ALSO NEED CONSIDERATION AND TREATED WITH FIBERGLASS BATTING.
- 7. RECOMMENDED SOUND TRANSMISSION CLASS FOR WALL CONSTRUCTION METHOD TO BE OF A STC-60 RATING. AT A MINIMUM, PARTITIONS SHOULD BE FILLED WITH BATT INSULATION AND COVERED WITH TWO LAYERS OF GWB ON BOTH SIDES.
- ACOUSTICAL REFLECTIONS OFF ALL GLASS SURFACES SHOULD BE ADDRESSED WITH APPROPRIATE WINDOW

#### TEL/DATA/TV:

- UNLESS OTHERWISE NOTED, THIS DRAWING ONLY REFLECTS THE MINIMUM TEL/DATA REQUIREMENTS NEEDED FOR THE USE OF THE AUDIO VISUAL EQUIPMENT AND SYSTEMS.
- ALL INDICATED LAN, TELEPHONE, CATV, MATV, AND DSS DROPS SHALL BE PROVIDED AND INSTALLED BY THE STRUCTURED CABLING CONTRACTOR

#### ELECTRICAL:

- ELECTRICAL POWER CIRCUITS AND OUTLETS SHOWN ON THESE DRAWINGS ARE FOR THE EXCLUSIVE USE OF THE AUDIOVISUAL SYSTEMS. CIRCUITS AND OUTLETS FOR OTHER PURPOSES ARE SPECIFIED ELSEWHERE.
- 2. ALL AV SYSTEM OUTLETS SHALL BE ISOLATED GROUND STYLE OUTLETS. ALL CIRCUITS SHALL BE PROVIDED WITH DEDICATED INSULATED GROUNDS RUN BACK TO THE PANEL. IN EACH ROOM ALL CIRCUITS SHALL BE FED FROM THE SAME PHASE AND PANEL.
- 3. POWER CIRCUITS FOR MOTORIZED PROJECTION SCREENS AND LIFTS SHALL NOT BE FED FROM THE SAME PHASE AS OTHER AUDIOVISUAL EQUIPMENT.
- 4. THE SIZE OF ALL WIREWAYS, BACK BOXES, AND CONDUITS SHOWN ON THESE DRAWINGS MUST BE CONFIRMED BY THE ARCHITECT AND ELECTRICAL ENGINEER. THE SIZES SHOWN ARE RECOMMENDATIONS TO THE ELECTRICAL ENGINEER ONLY.
- ALL CONDUIT, PULL BOXES, TROUGH, WIRE WAYS, RACEWAYS, LADDER RACK AND OTHER INFRASTRUCTURE TO PROVIDE CABLE PATHWAYS FOR AUDIOVISUAL CABLING SHALL BE PROVIDED AND INSTALLED BY BASE ELECTRICAL CONTRACTOR.
- 6. ALL CONDUIT SHALL BE CLEAN, DRY AND DEBURRED, WITH PULL STRINGS LEFT INSIDE.
- AUDIOVISUAL CONDUIT RUNS SHOULD BE KEPT FURTHER THAN 12 INCHES FROM ALL POWER AND LIGHTING CONDUITS. AV CONDUITS MUST NOT BE RUN PARALLEL TO POWER OR LIGHTING CONDUITS. WHERE AV CONDUITS MUST CROSS POWER OR LIGHTING CONDUITS, THEY MUST DO SO AT RIGHT ANGLES.
- 8. MOTORIZED SHADE AND DRAPE SYSTEMS SHOULD BE OUTFITTED WITH LOW VOLTAGE CONTROLLERS FOR INTERFACING WITH THE AUDIOVISUAL CONTROL SYSTEM. COORDINATE THESE CONTROLLERS WITH AUDIOVISUAL CONTRACTOR PRIOR TO PURCHASE OR INSTALLATION.



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Reviewed By:


01/08/201 SUE FOR COORDINATION 0/25/20 SUE FOR REVIEW DATE DESCRIPTION

DATE: 10/25/2018 SCALE: AS NOTED DRAWN: B.HOAGE ENG BY: S. O'DONNELI

ARCH D 36 X 24

**AUDIOVISUAL** RESPONSIBILITIES

L06877 TA00-001 Audiovisual Notes and Responsibilities.dwg

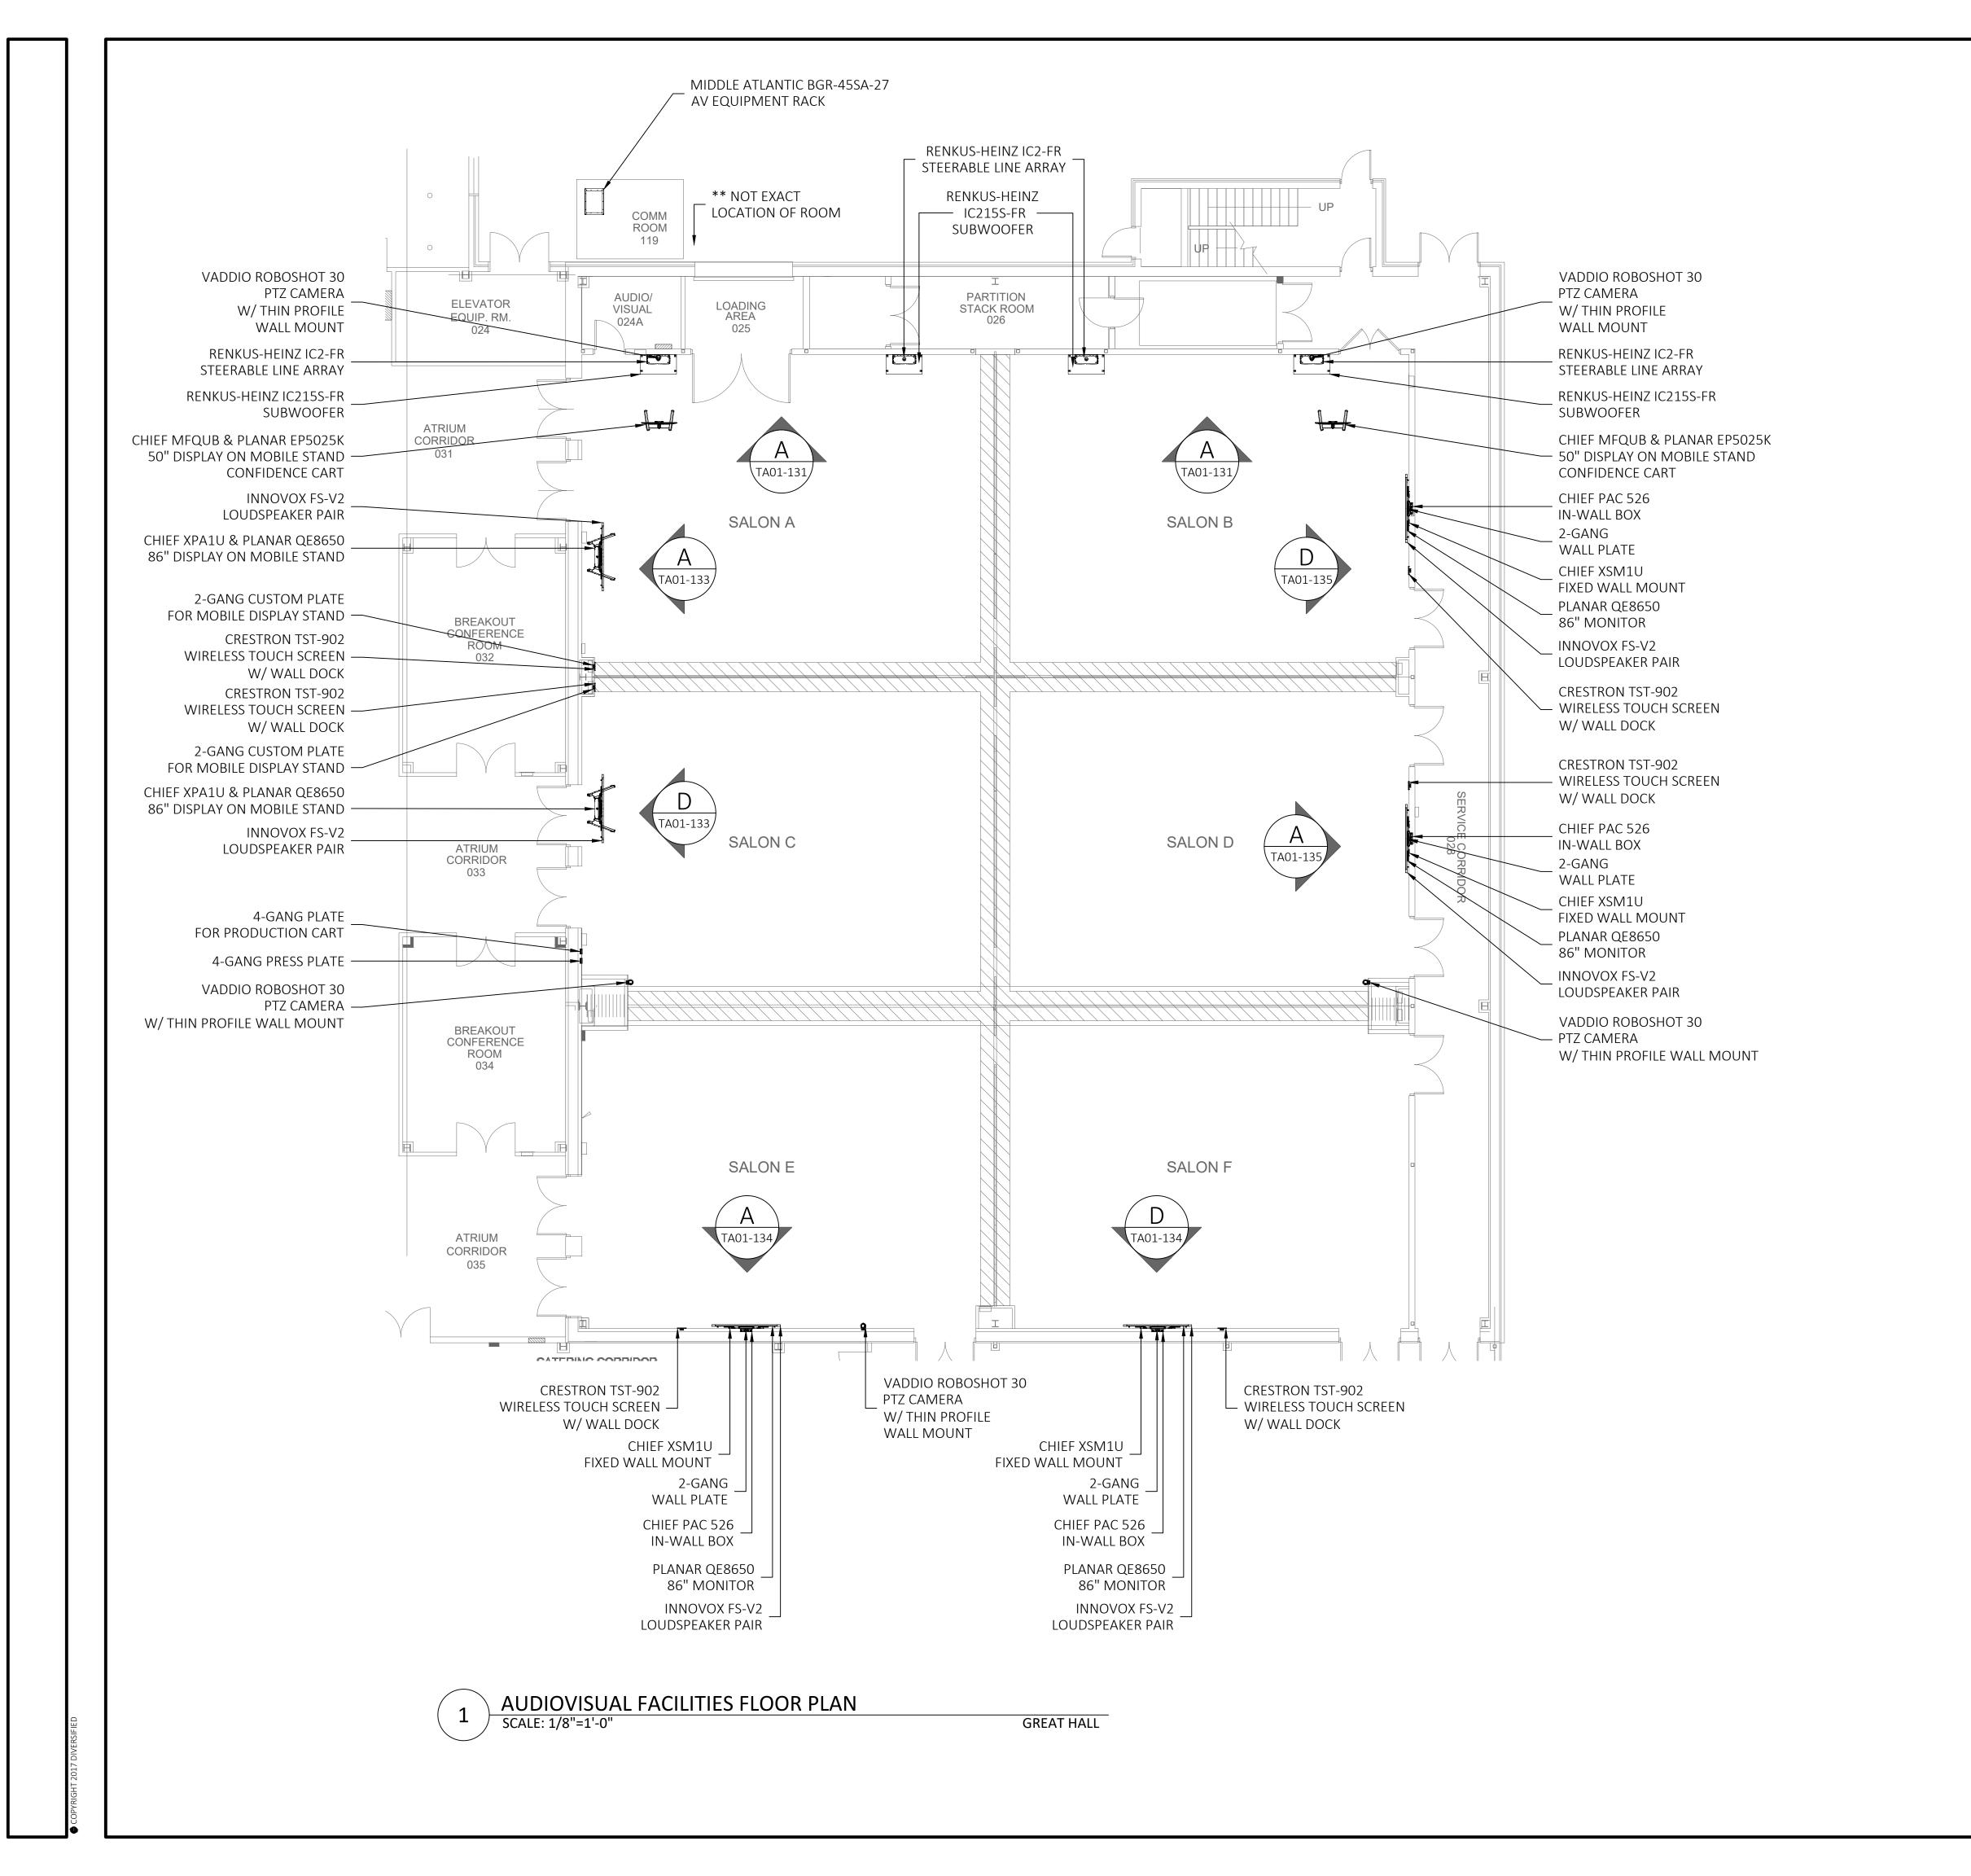



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Reviewed By:

Date:

1 01/08/2019 ISSUE FOR COORDINATION
0 10/25/2018 ISSUE FOR REVIEW

REV DATE DESCRIPTION

DATE: 10/25/2018 SCALE: 1/8" = 1'-0" DRAWN: B.HOAGE ENG BY: S.ODONNELL


SHEET SIZE ARCH D 36 X 24

GREAT HALL
AUDIOVISUAL
FACILITIES
FLOOR
PLAN

DRAWING NO

TA01-101

L06877

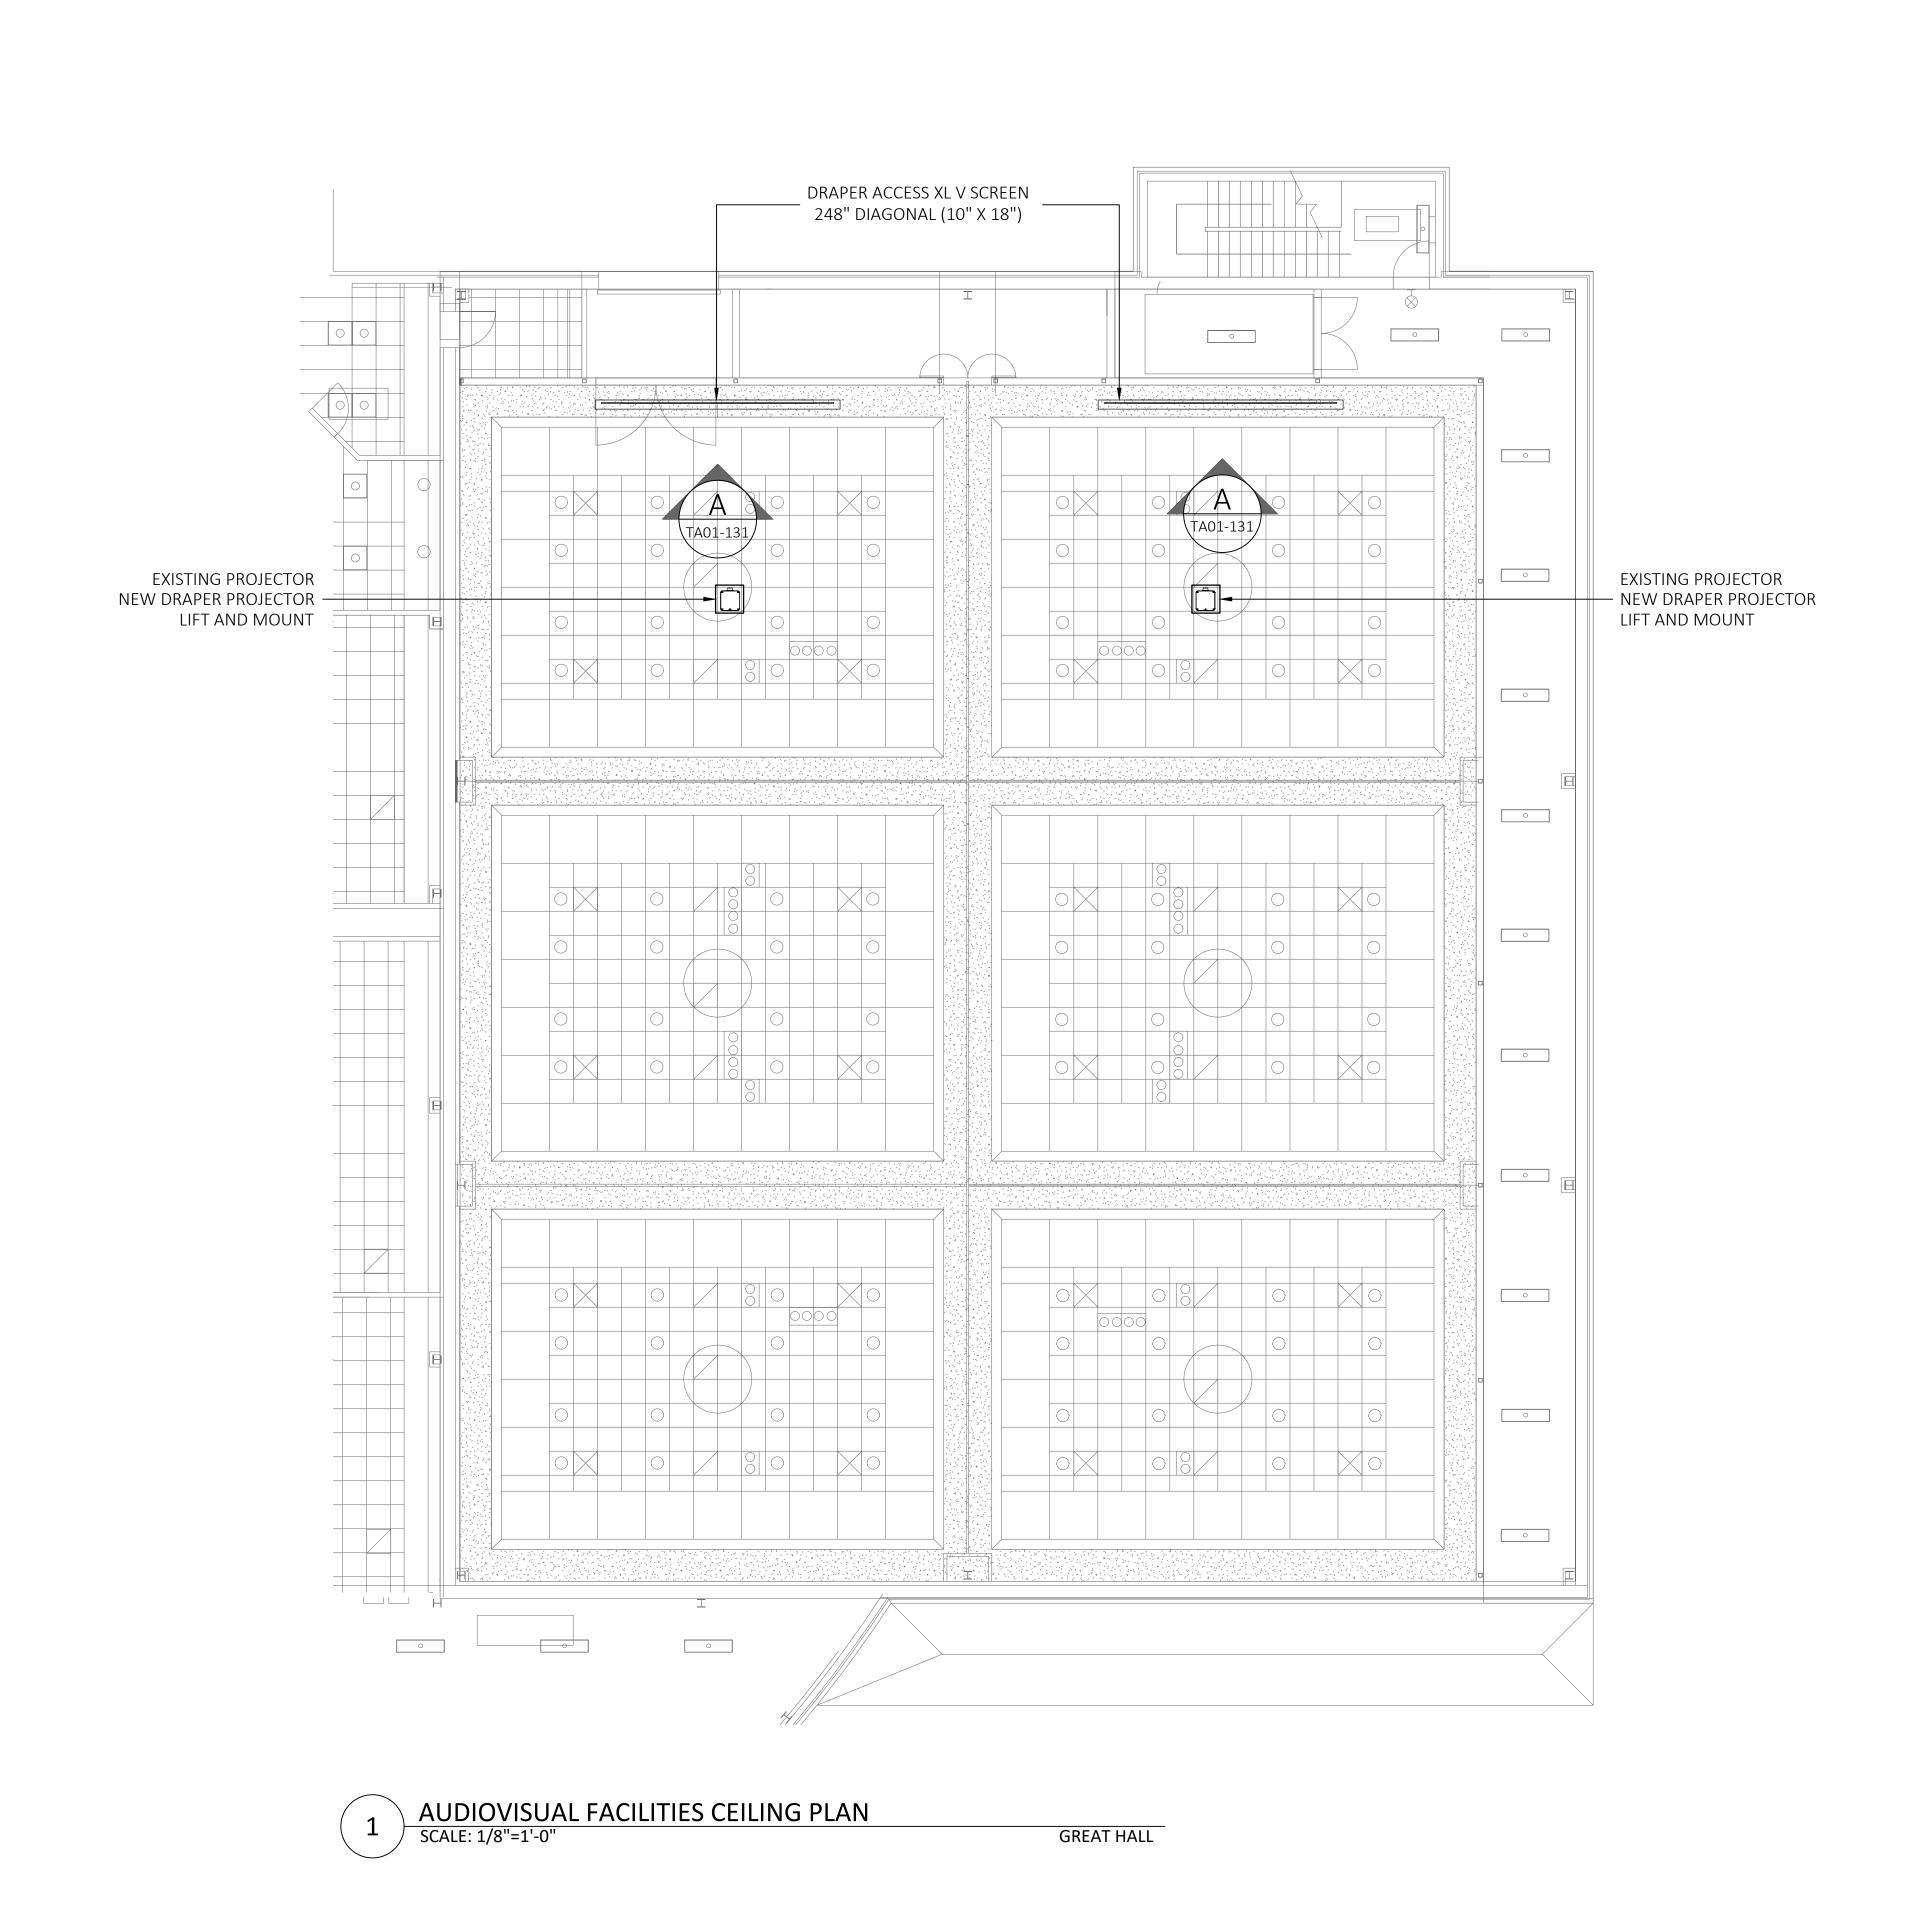

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Date:\_

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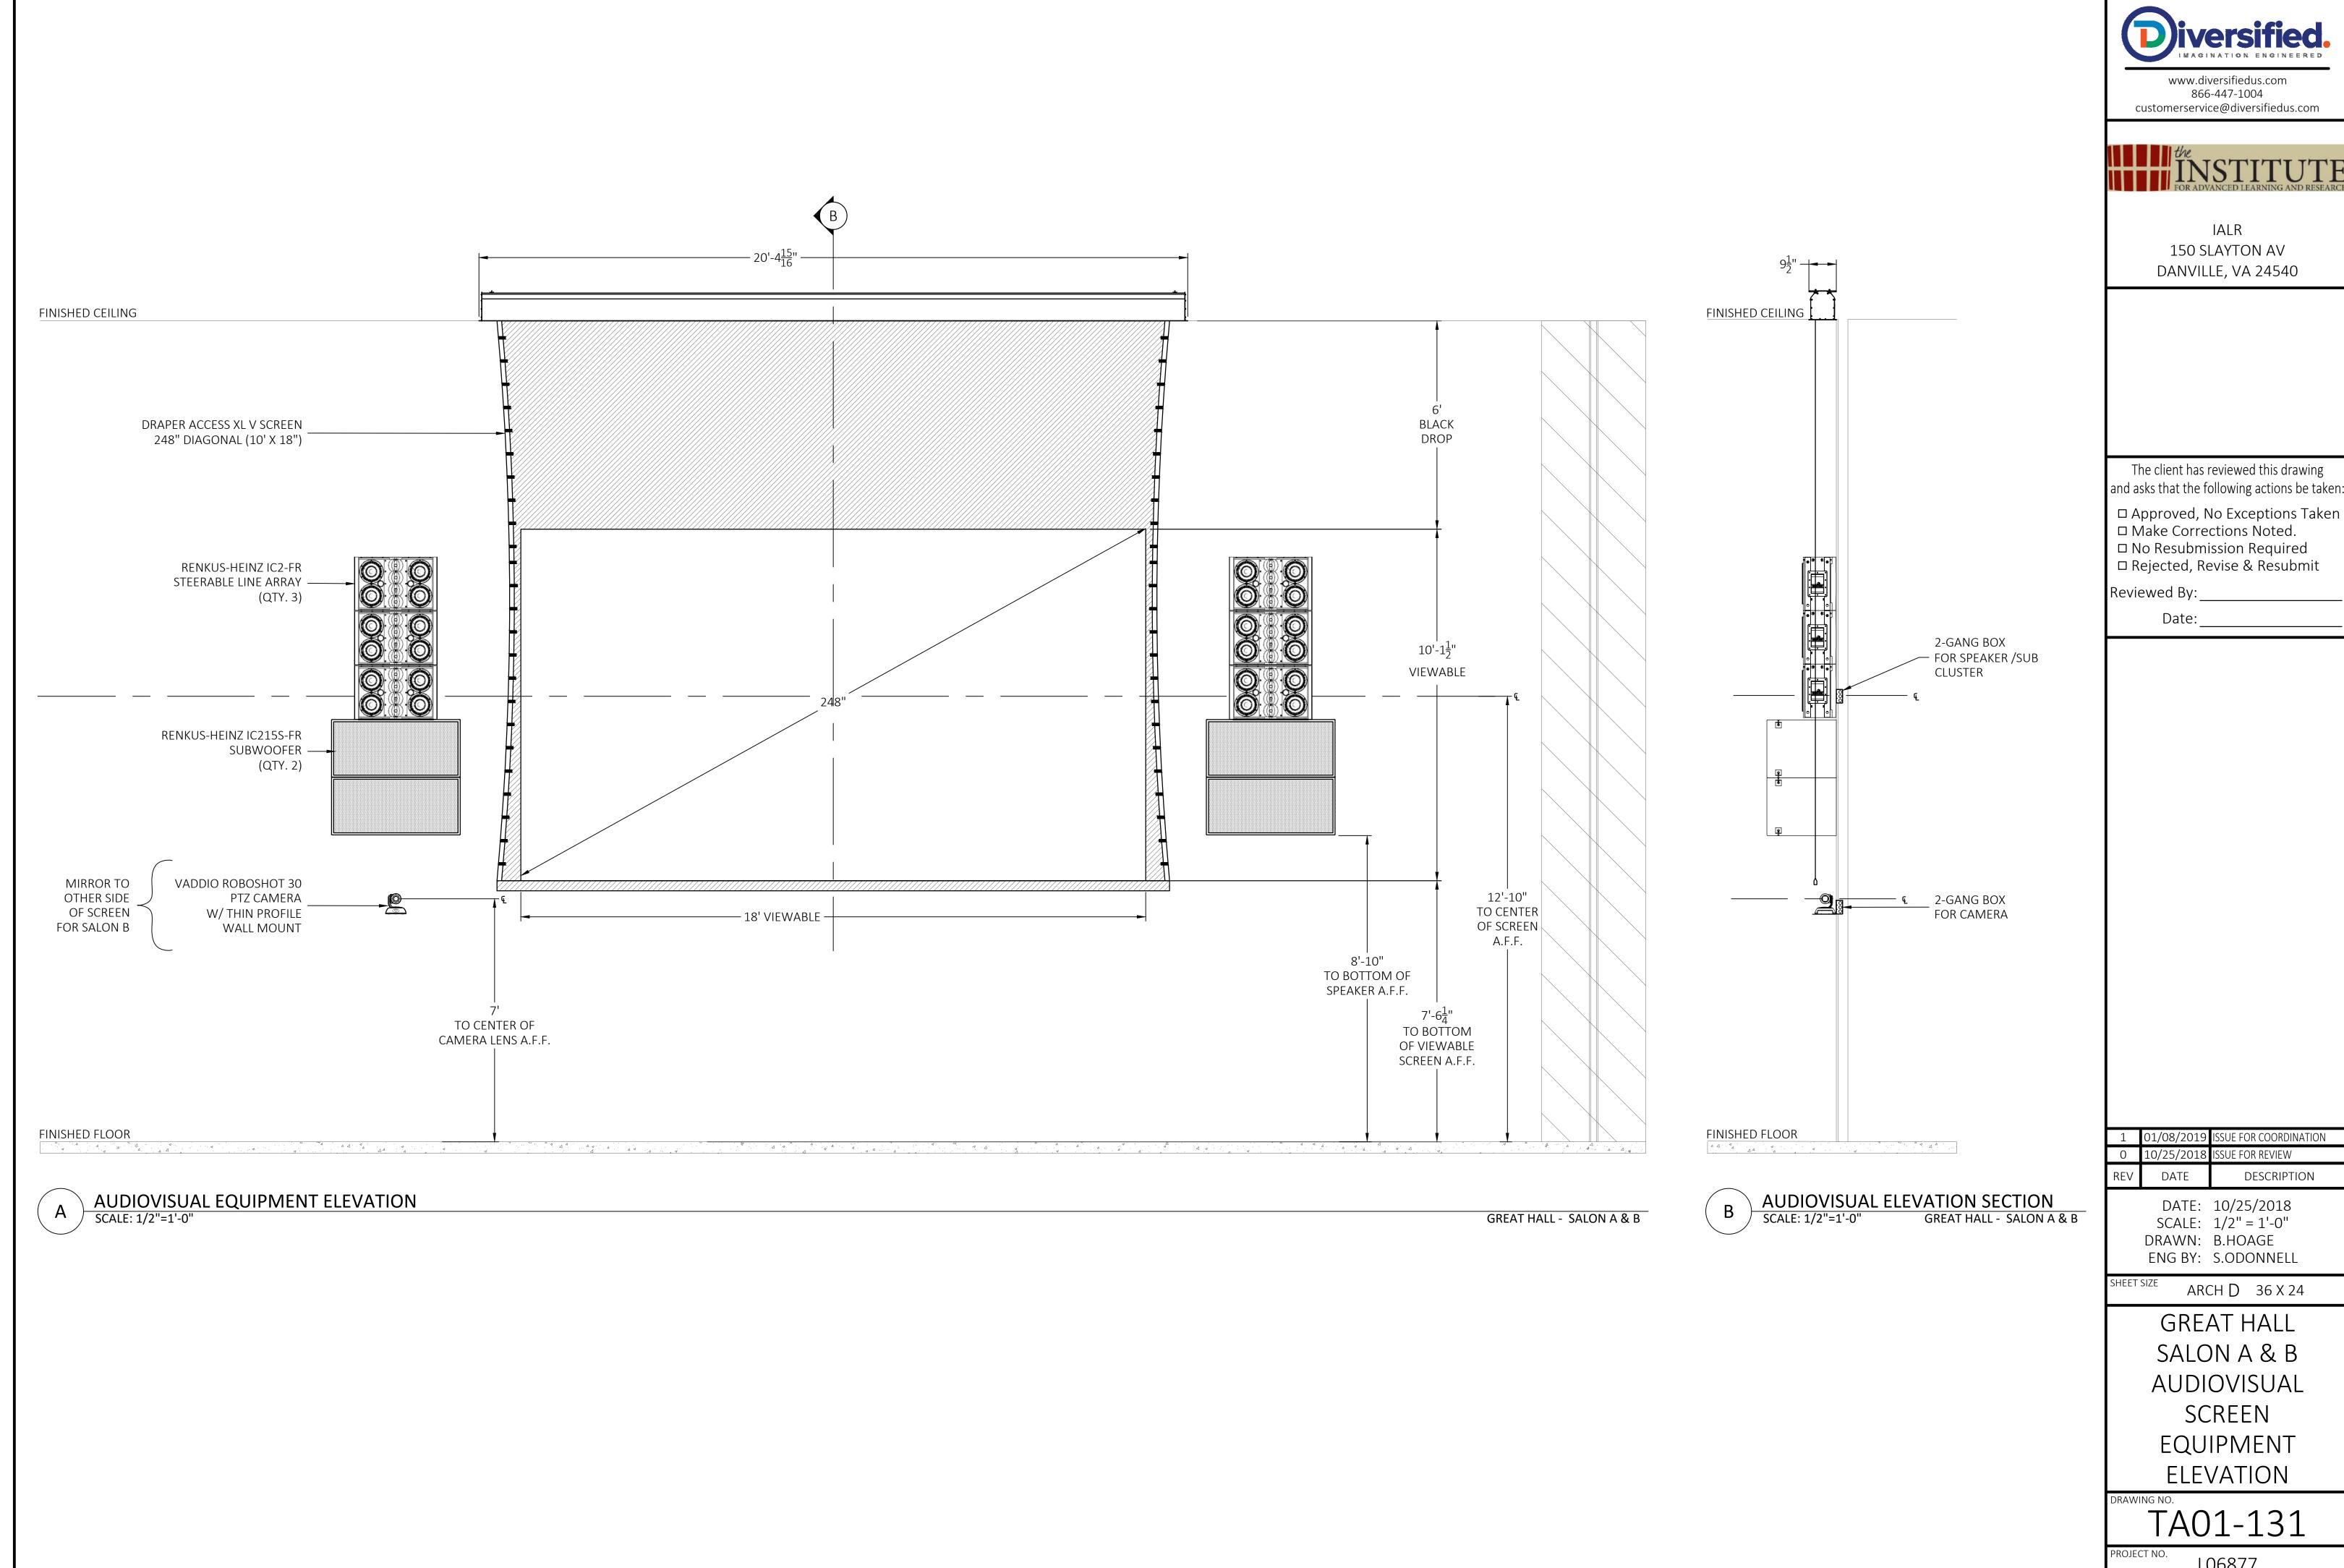
SHEET SIZE ARCH D 36 X 24

GREAT HALL
AUDIOVISUAL
FACILITIES
CEILING
PLAN

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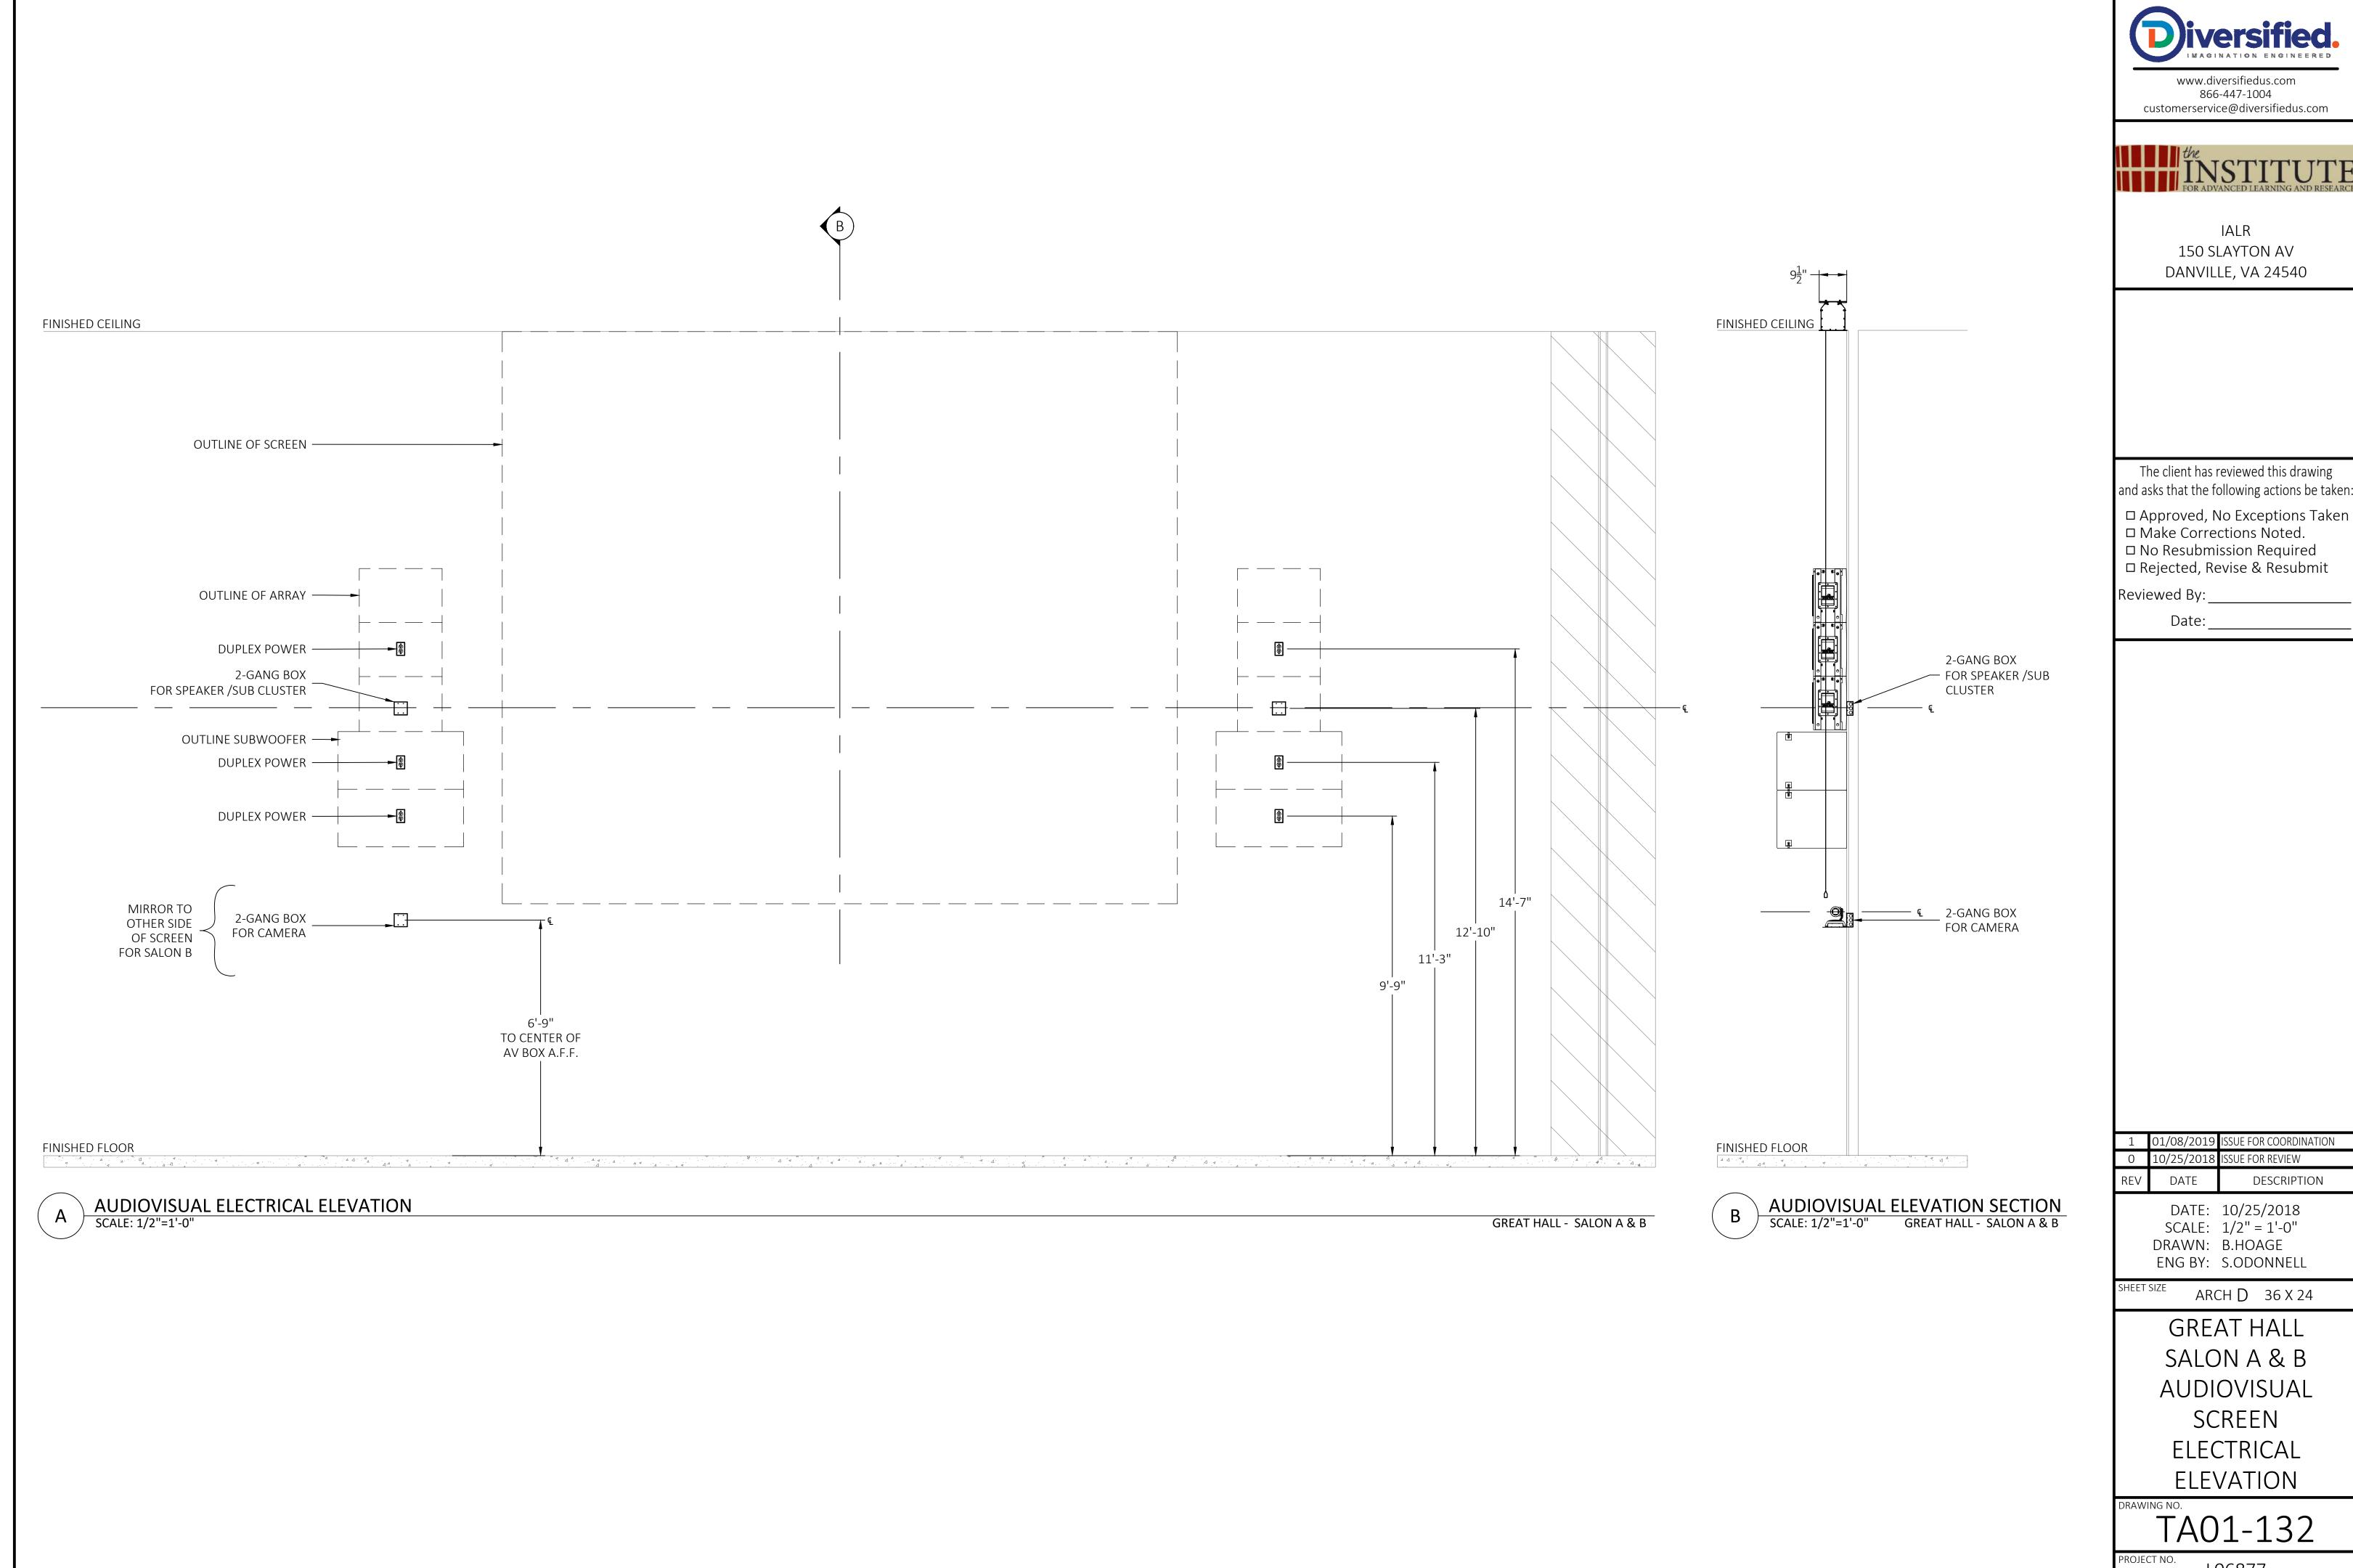
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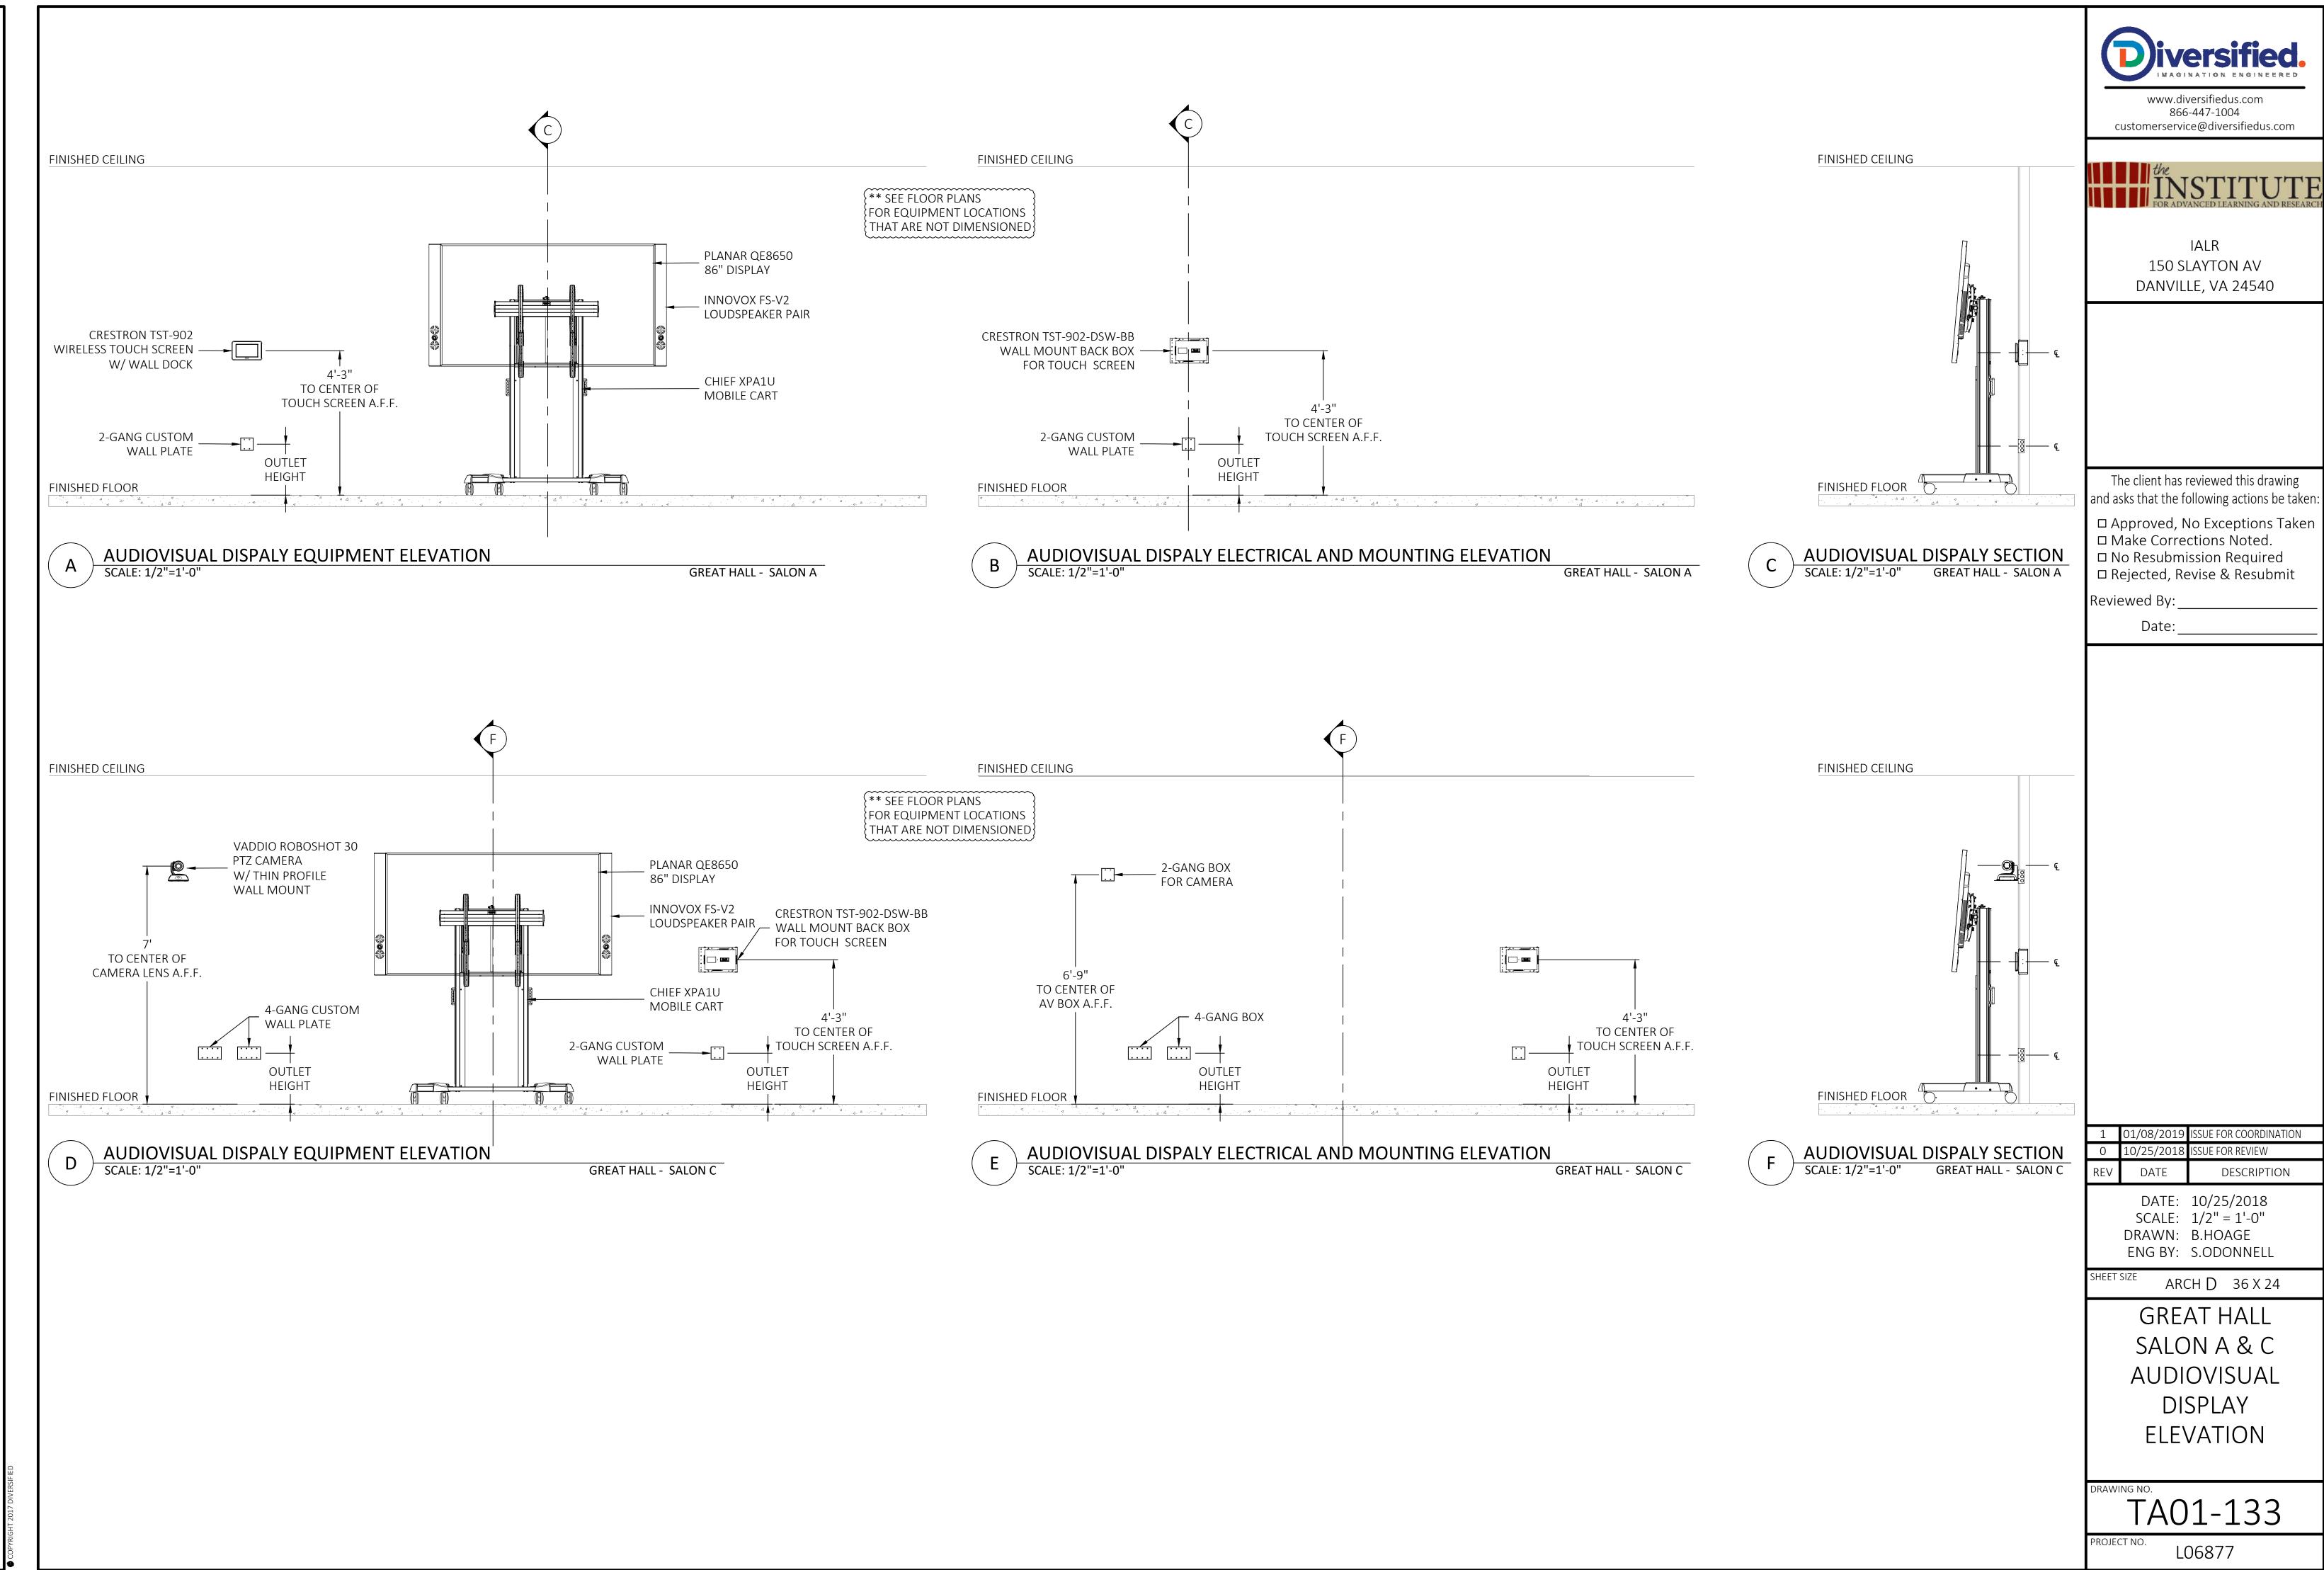





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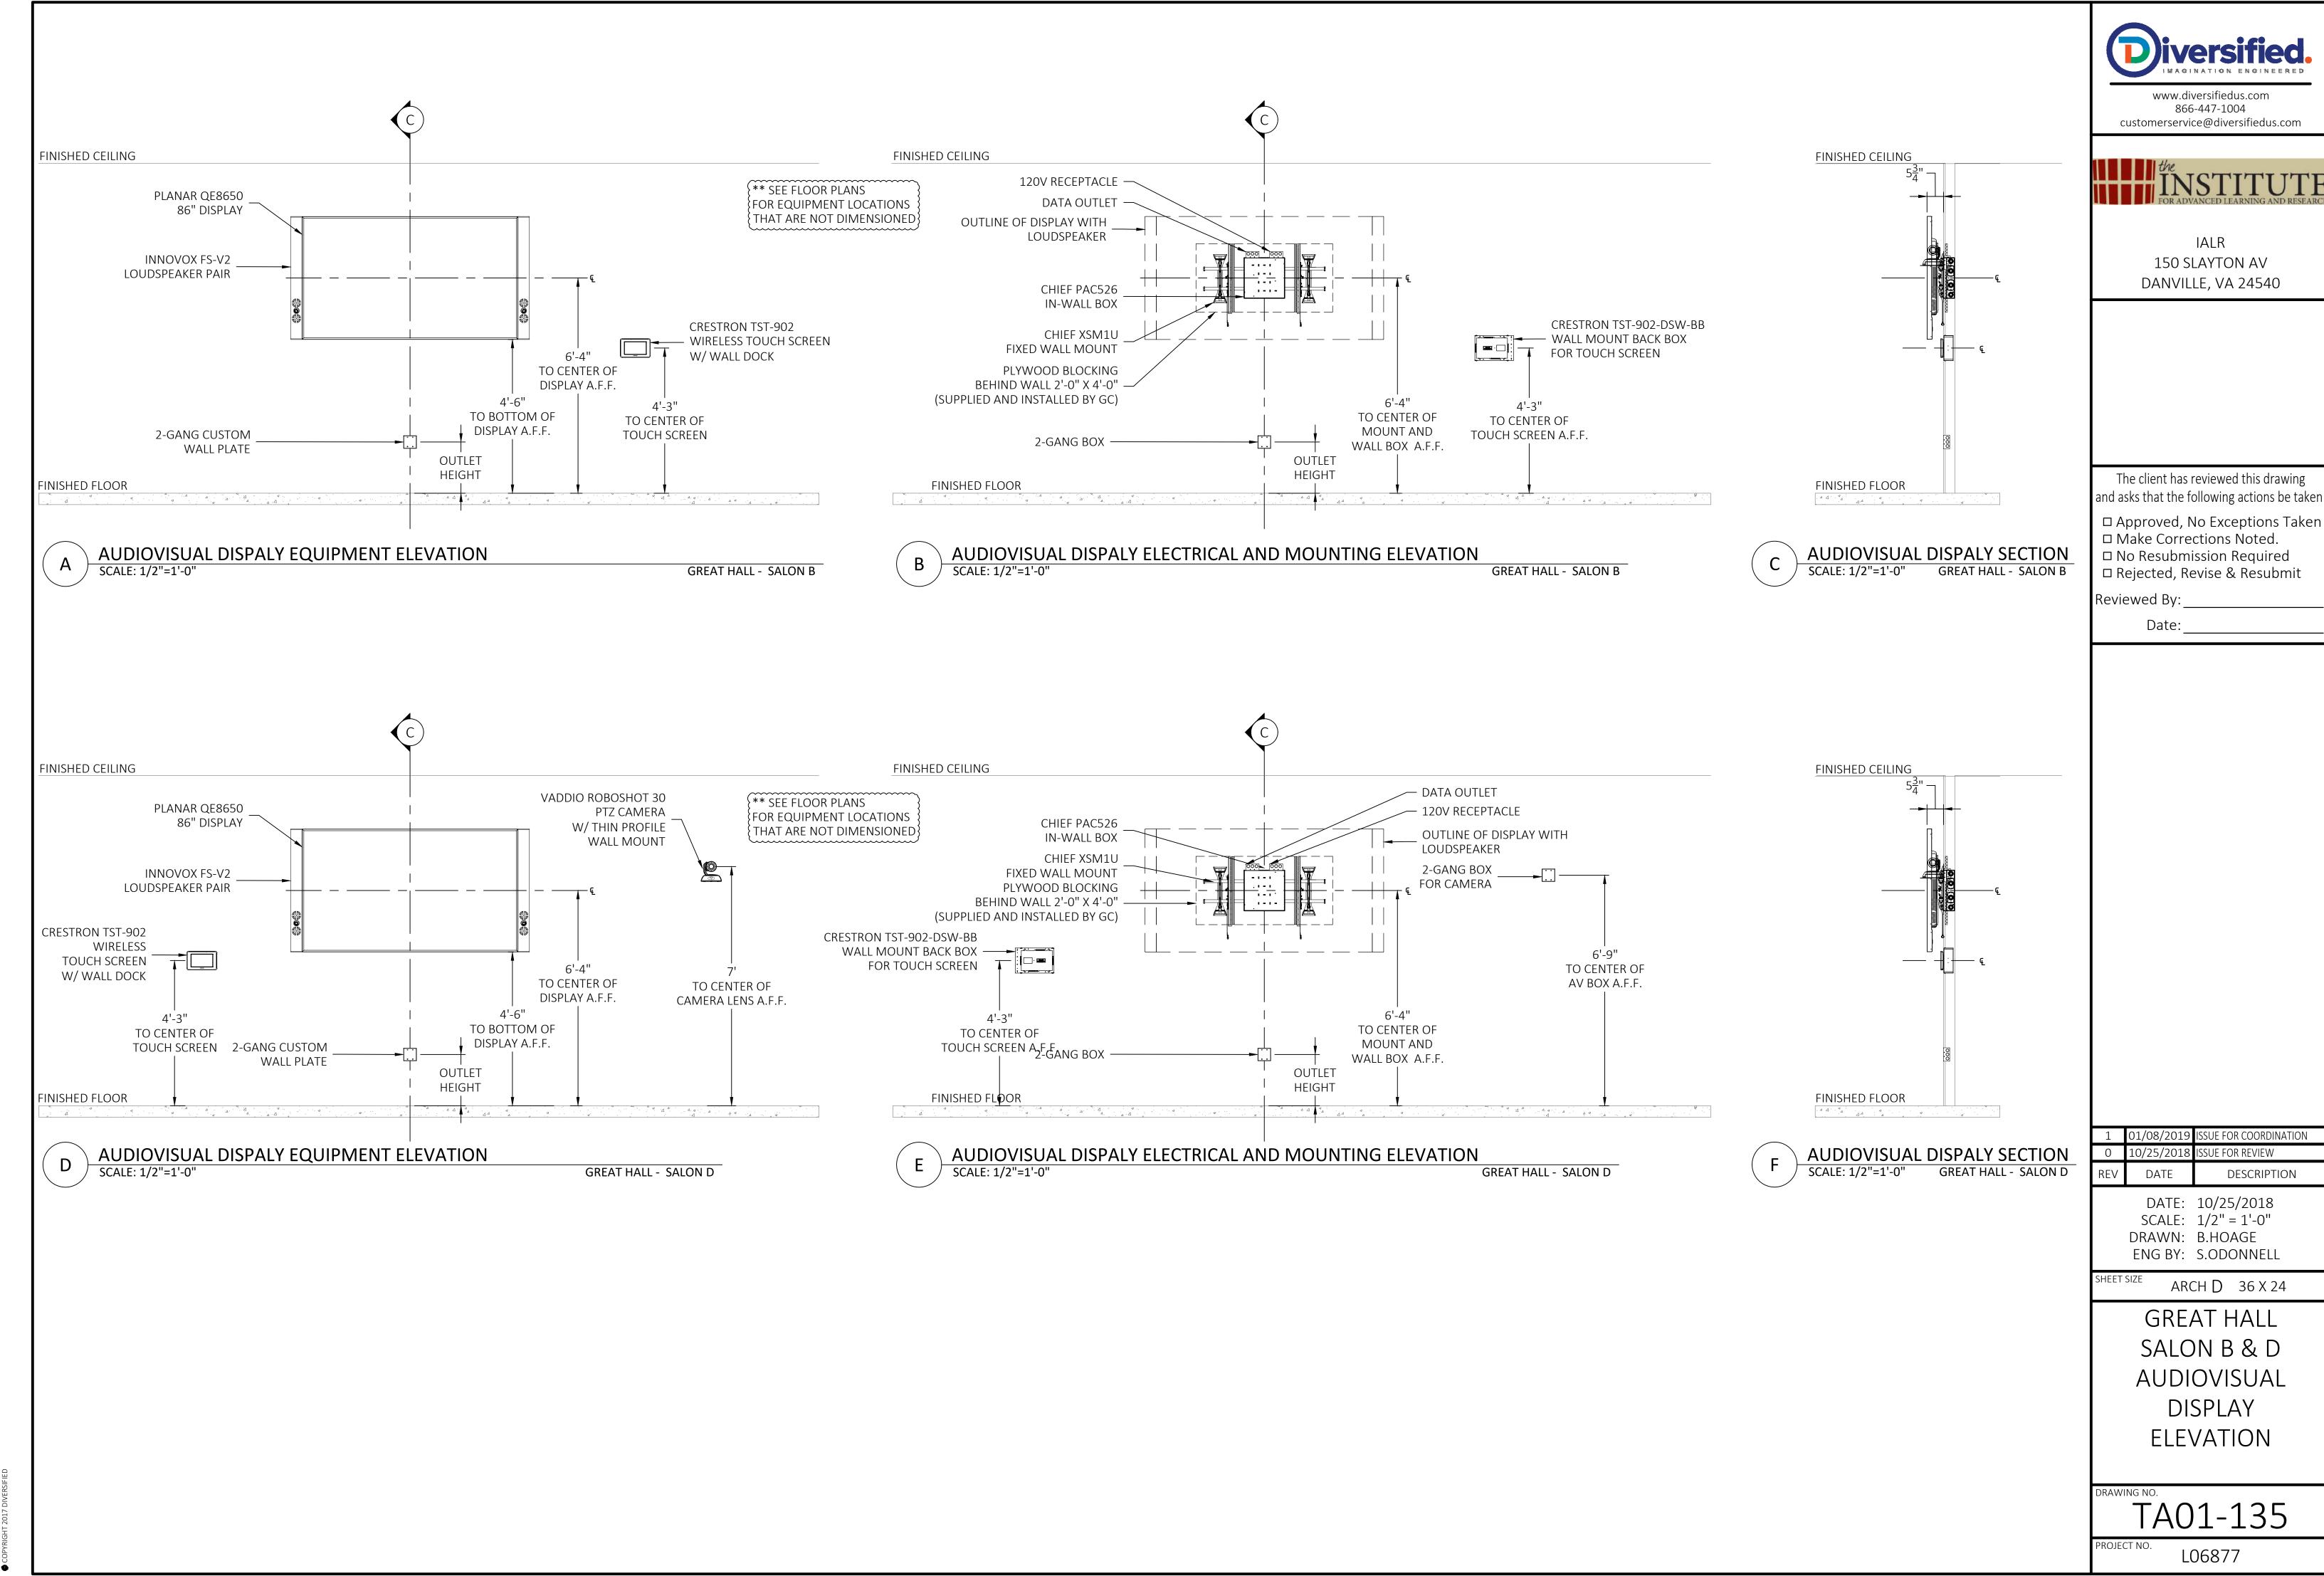
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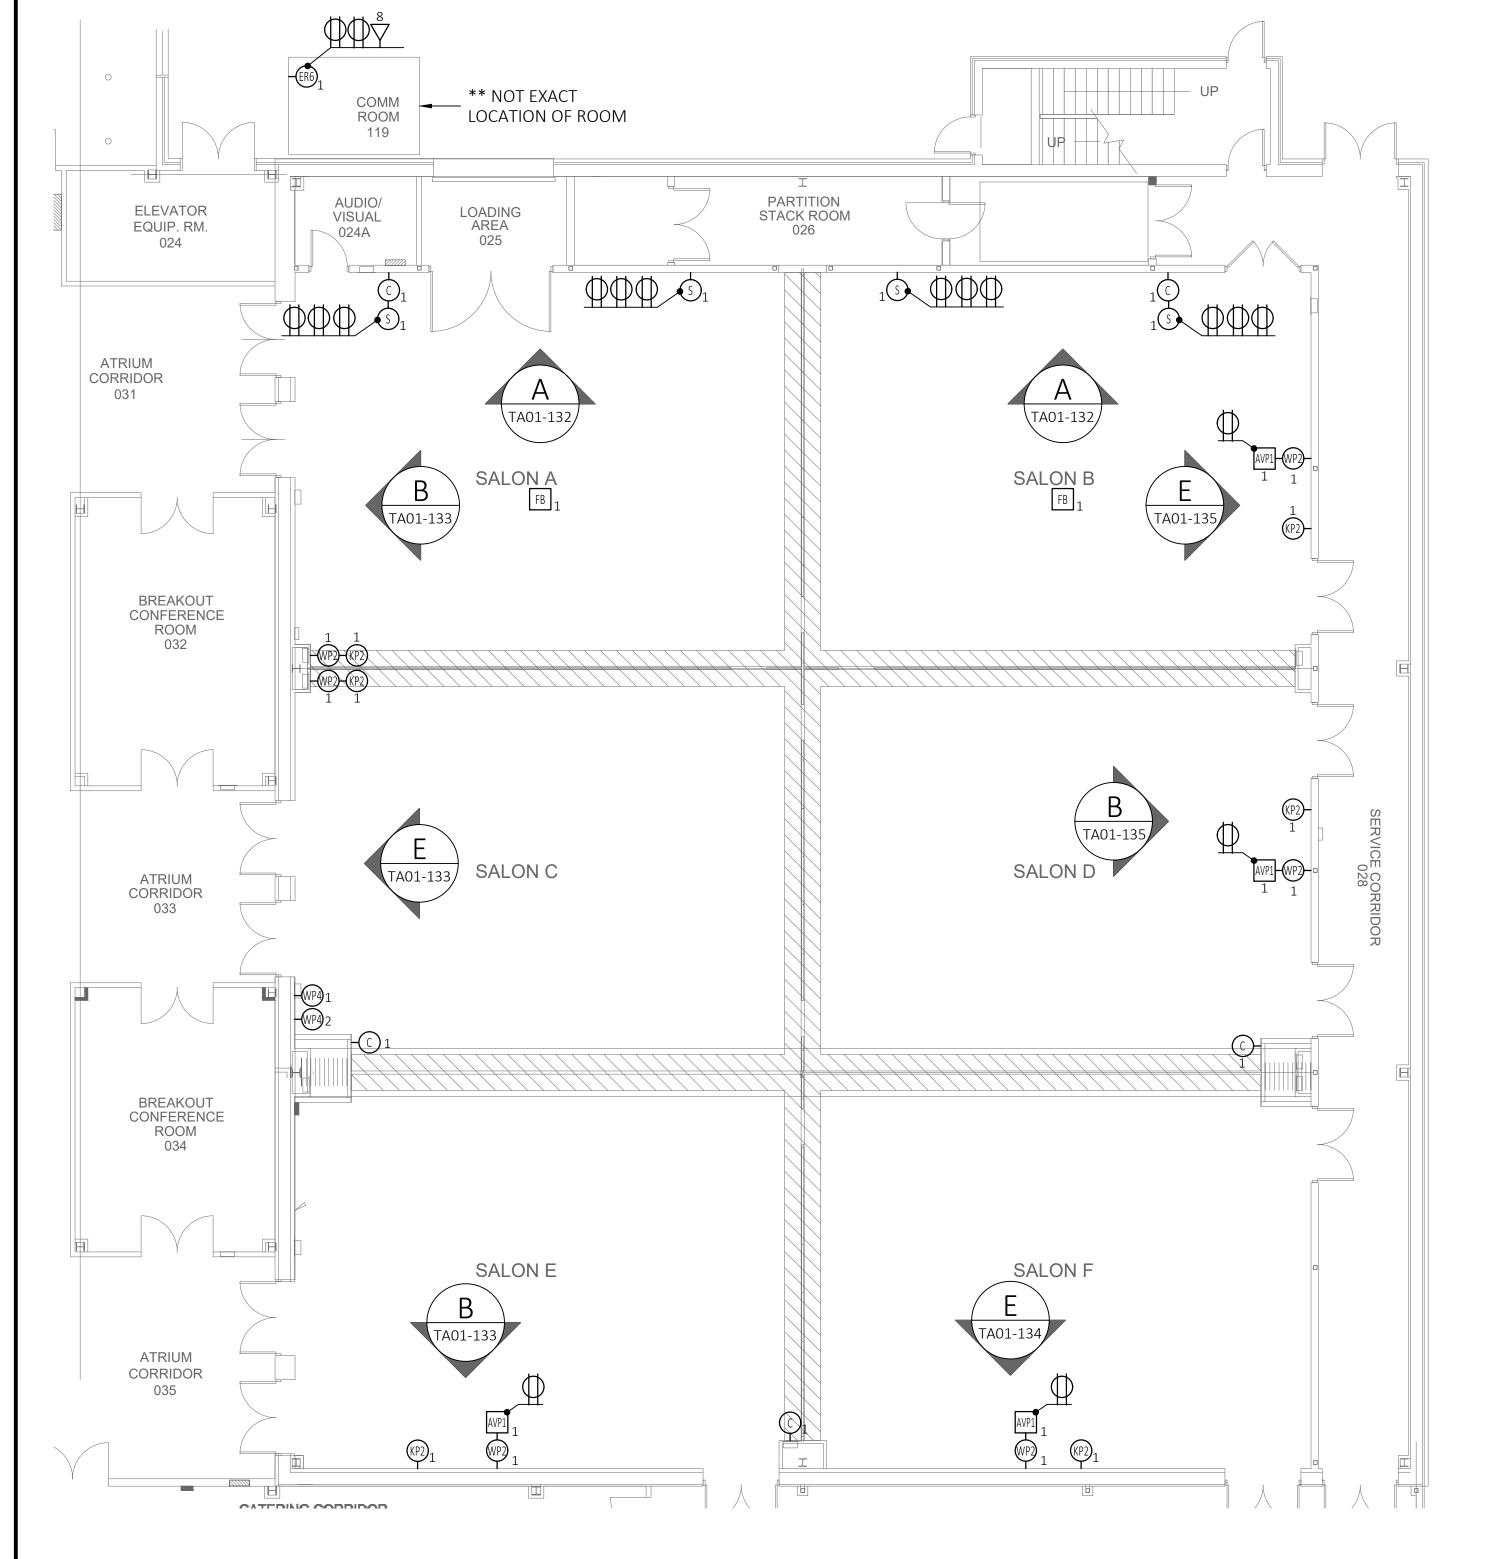
L06877 TA01-133 Great Hall - Salon A & C - Audiovisual Display Elevations.dwg



L06877 TA01-134 Great Hall - Salon E & F - Audiovisual Display Elevations.dwg



L06877 TA01-135 Great Hall - Salon B & D - Audiovisual Display Elevations.dwg

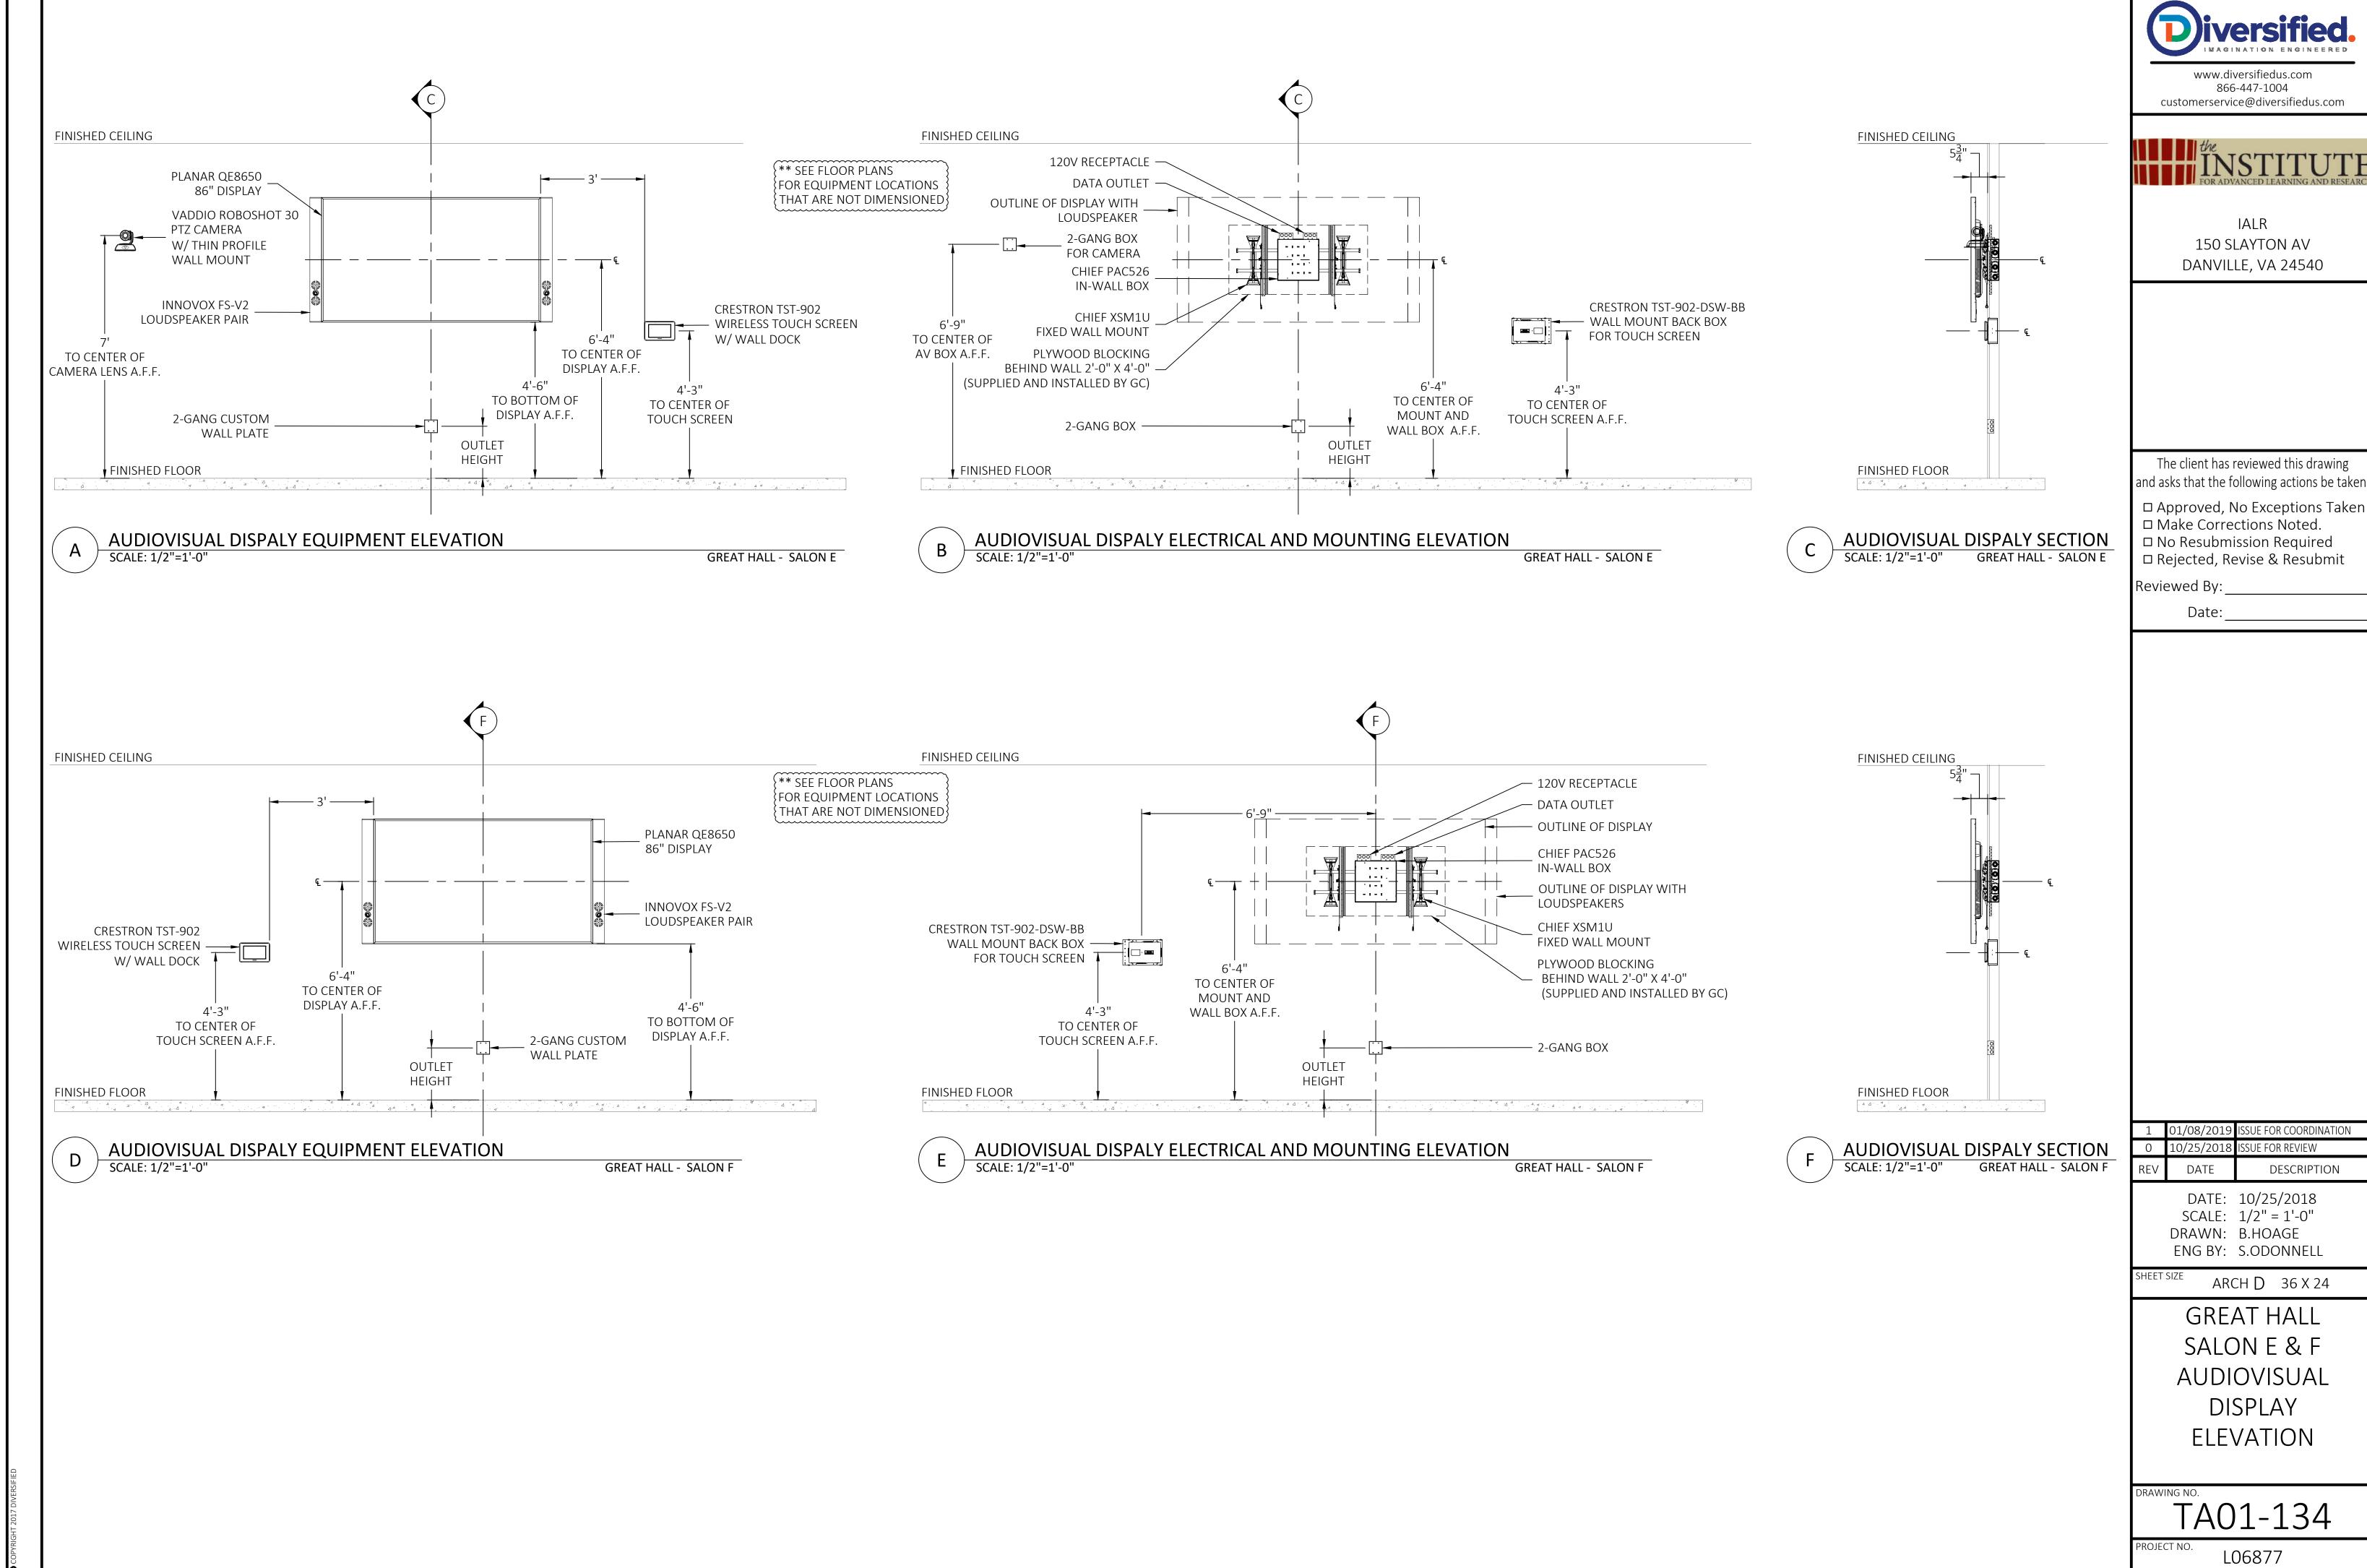

GREAT HALL

	AV JUNCTION BOX A	AND DEVICE SCHEDULE	
SYMBOL	FUNCTION	DESCRIPTION	SLACK
-AV2 <sub>X</sub>	AV WALL BOX, 'X' = BOX NUMBER	2 GANG RECESS MOUNTED BACK BOX	10'
-AVP1 <sub>X</sub>	AV WALL BOX, 'X' = BOX NUMBER	CHIEF PAC526 BACK BOX (PROVIDED BY AVC AND INSTALLED BY G.C.)	10'
-WP2) <sub>X</sub>	AV WALL CONNECTION PLATE, 'X' = PLATE NUMBER	2 GANG RECESS MOUNTED BACK BOX	10'
-WP4) <sub>X</sub>	AV WALL CONNECTION PLATE, 'X' = PLATE NUMBER	4 GANG RECESS MOUNTED BACK BOX	10'
-(KP2) <sub>X</sub>	AV CONTROL KEYPAD, 'X' = BOX NUMBER	CRESTRON TST-902-DSW-BB BACK BOX	10'
-ER6) <sub>X</sub>	EQUIPMENT RACK, 'X' = BOX NUMBER	12 X 12 NEMA JUNCTION BOX	20'
FBX	EXISTING FLOOR BOX	EXISTING FLOOR BOX	N/A
-C) <sub>X</sub>	VTC CAMERA , 'X' = CAMERA NUMBER	WALL MOUNTED CAMERA, 2 GANG RECESS MOUNT BACK BOX	10'
© <sub>X</sub>	CEILING VTC CAMERA , 'X' = CAMERA NUMBER	CEILING MOUNTED CAMERA	10'
-(S) <sub>X</sub>	WALL MOUNTED SPEAKER, 'X' = SPEAKER NUMBER	WALL MOUNTED SPEAKER, 2 GANG RECESS MOUNT BACK BOX	5'
$\bigcirc$ X	CEILING SPEAKER , 'X' = SPEAKER NUMBER	CEILING MOUNTED SPEAKER	10'
PX	EXISTING AV CEILING MOUNTED PROJECTOR	EXISTING CEILING MOUNTED PROJECTOR	10'
(LVC) <sub>X</sub>	PROJECTION SCREEN INTEGRATED LVC, 'X' = SCREEN NUMBER	1 GANG JUNCTION BOX MOUNTED TO SIDE OF SCREEN HOUSING	5'
TP X	TABLE MOUNTED TOUCH PANEL, 'X' = TOUCH PANEL NUMBER	TABLETOP MOUNTED TOUCH PANEL	10'
<b>→</b> 2	2 PORT WALL MOUNTED DATA OUTLET	N/A	N/A
$\rightarrow$	120V, 20A, WALL MOUNTED DUPLEX POWER OUTLET	N/A	N/A
	120V, 20A, CEILING/CABLE TRAY MOUNTED DUPLEX POWER OUTLET	N/A	N/A



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IALR 150 SLAYTON AV DANVILLE, VA 24540

The client has reviewed this drawing and asks that the following actions be taken

□ Approved, No Exceptions Taken □ Make Corrections Noted. □ No Resubmission Required □ Rejected, Revise & Resubmit

Reviewed By:

01/08/201 SUE FOR COORDINATION DATE DESCRIPTION

DATE: 10/25/2018 SCALE: 1/8" = 1'-0" DRAWN: B.HOAGE ENG BY: S.ODONNELL

ARCH D 36 X 24


**GREAT HALL AUDIOVISUAL** ELECTRICAL FLOOR PLAN


TA01-201

L06877

AUDIOVISUAL ELECTRICAL FLOOR PLAN
SCALE: 1/8"=1'-0"

L06877 TA01-201 Great Hall - Audiovisual Electrical Floor Plan.dwg

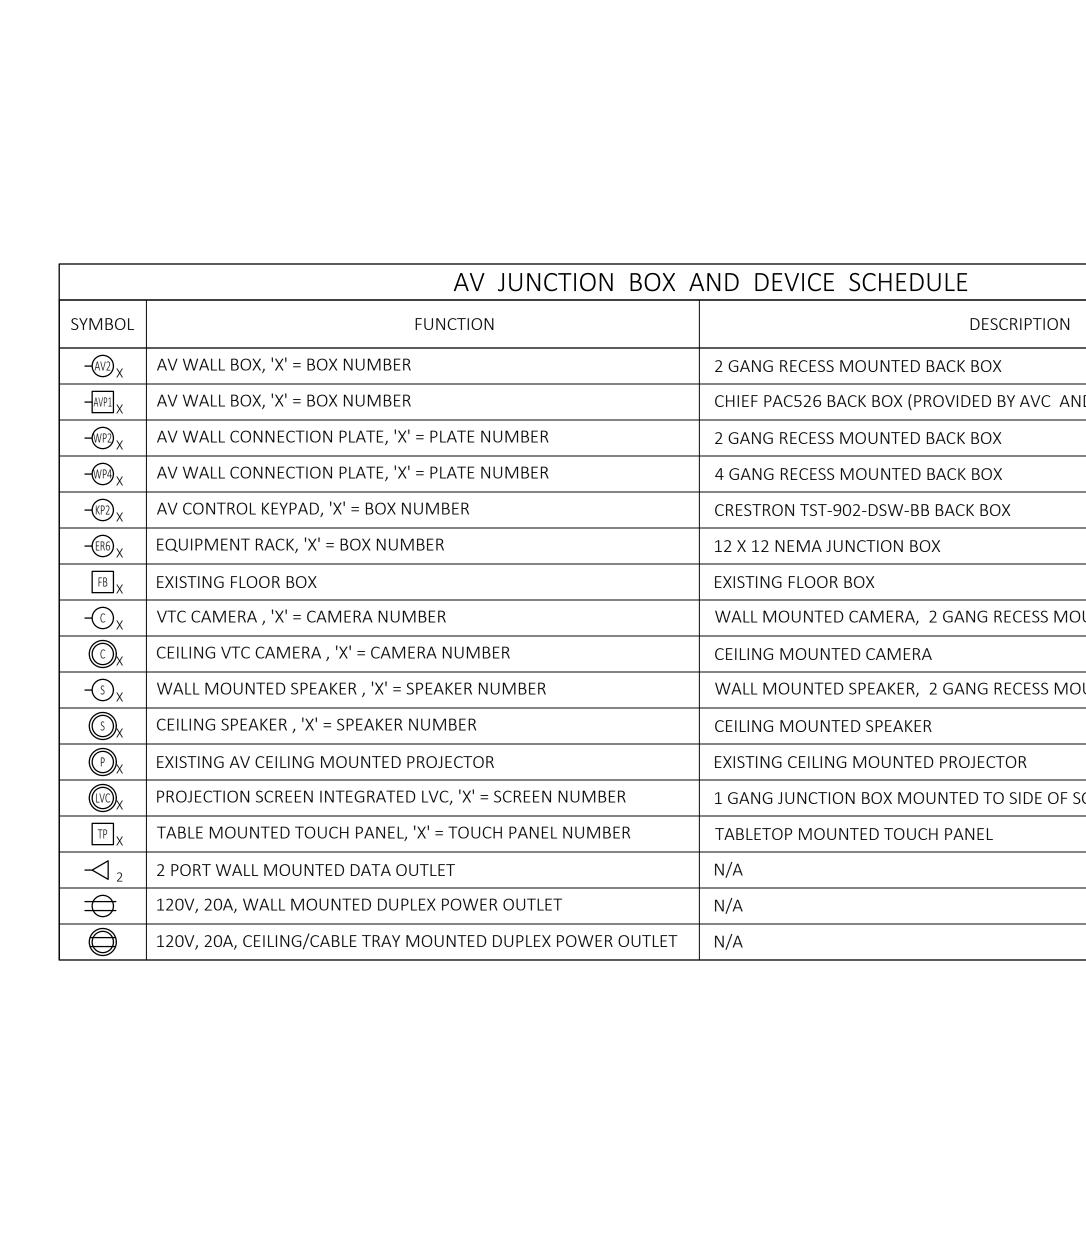

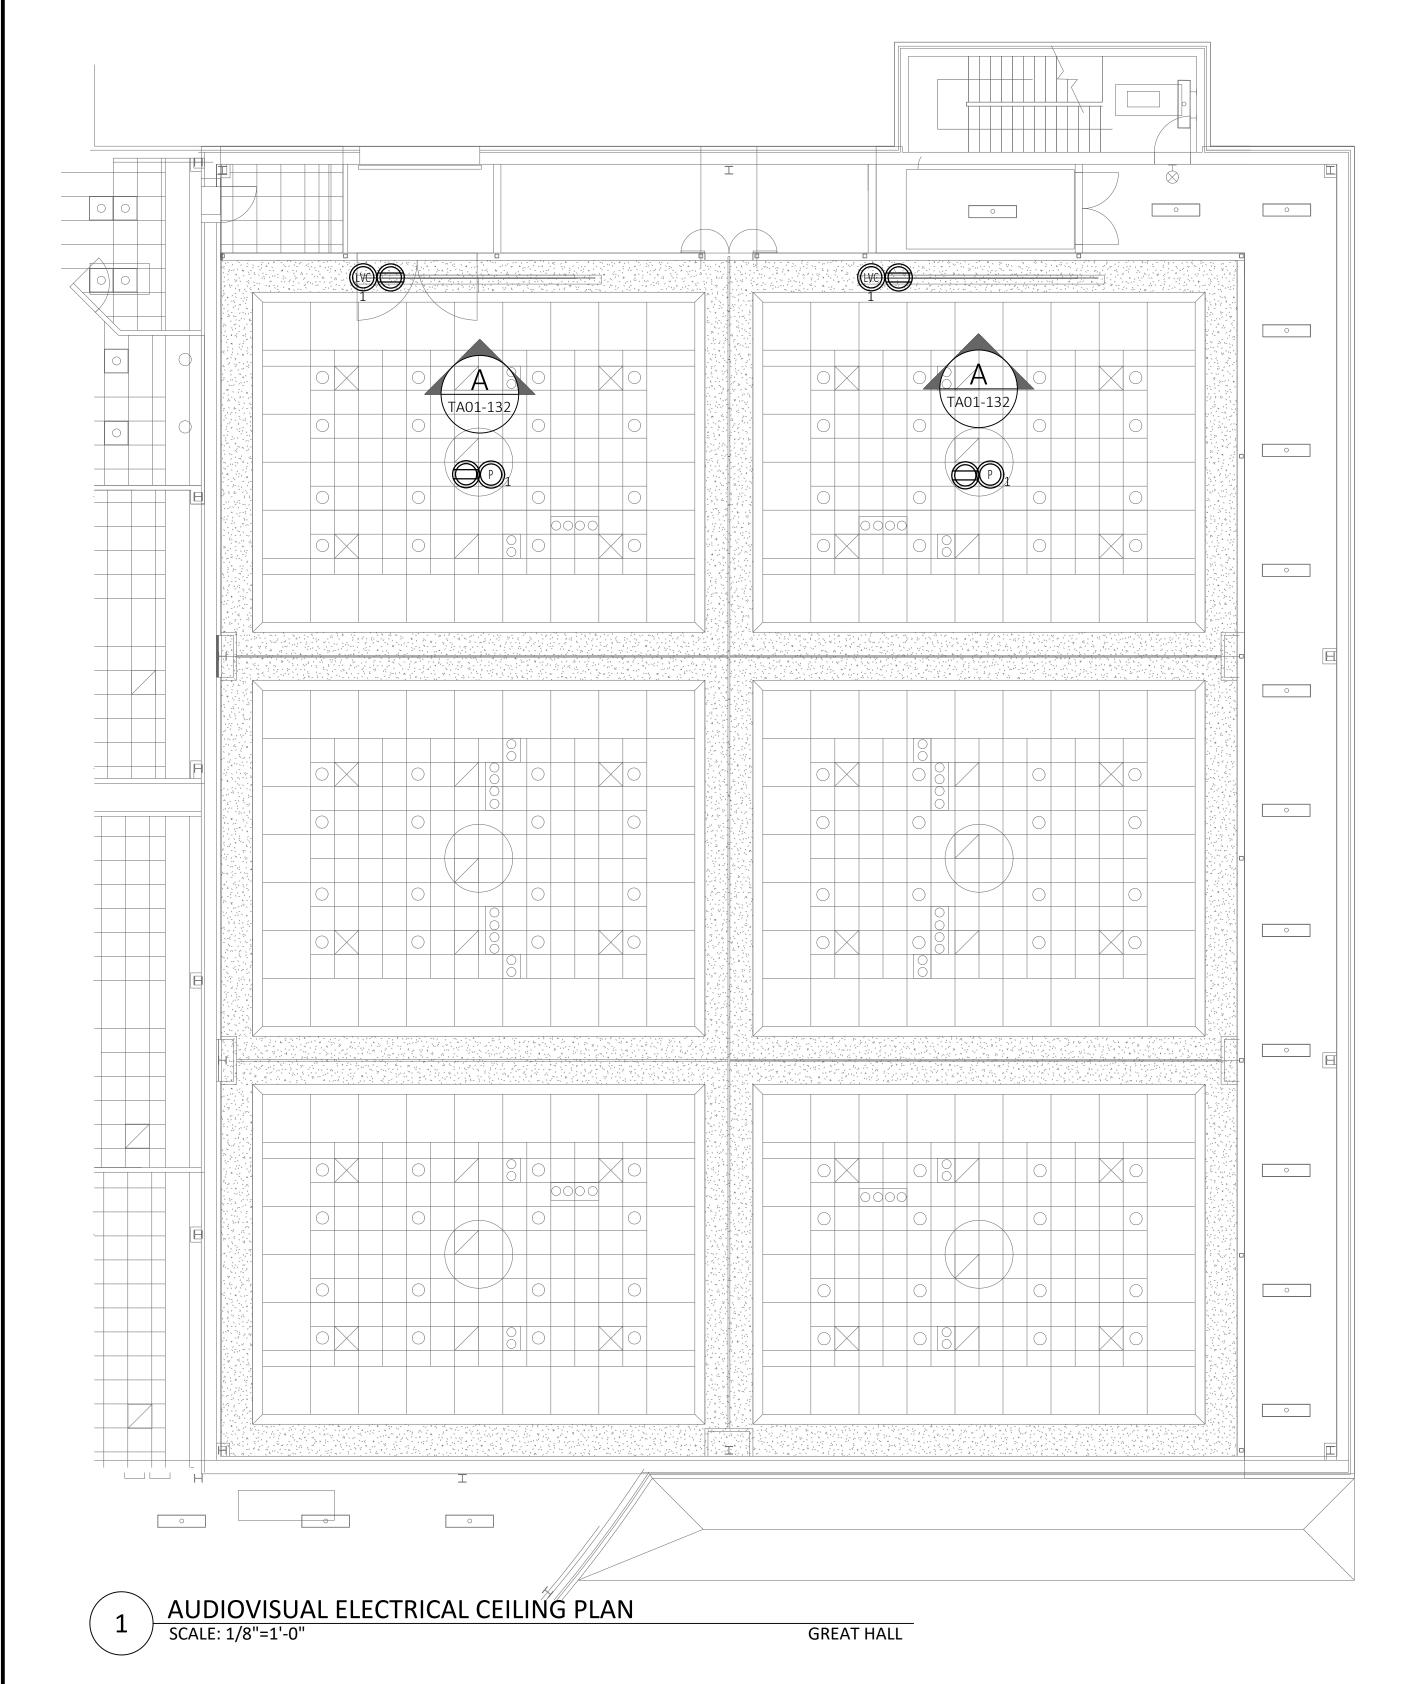

	AV JUNCTION BOX A	AND DEVICE SCHEDULE	
SYMBOL	FUNCTION	DESCRIPTION	SLACK
-AV2) <sub>X</sub>	AV WALL BOX, 'X' = BOX NUMBER	2 GANG RECESS MOUNTED BACK BOX	10'
-AVP1 X	AV WALL BOX, 'X' = BOX NUMBER	CHIEF PAC526 BACK BOX (PROVIDED BY AVC AND INSTALLED BY G.C.)	10'
-WP2) <sub>X</sub>	AV WALL CONNECTION PLATE, 'X' = PLATE NUMBER	2 GANG RECESS MOUNTED BACK BOX	10'
-WP4) <sub>X</sub>	AV WALL CONNECTION PLATE, 'X' = PLATE NUMBER	4 GANG RECESS MOUNTED BACK BOX	10'
-KP2) <sub>X</sub>	AV CONTROL KEYPAD, 'X' = BOX NUMBER	CRESTRON TST-902-DSW-BB BACK BOX	10'
-ER6 <sub>X</sub>	EQUIPMENT RACK, 'X' = BOX NUMBER	12 X 12 NEMA JUNCTION BOX	20'
FBX	EXISTING FLOOR BOX	EXISTING FLOOR BOX	N/A
-C)X	VTC CAMERA , 'X' = CAMERA NUMBER	WALL MOUNTED CAMERA, 2 GANG RECESS MOUNT BACK BOX	10'
© <sub>X</sub>	CEILING VTC CAMERA , 'X' = CAMERA NUMBER	CEILING MOUNTED CAMERA	10'
-(S) <sub>X</sub>	WALL MOUNTED SPEAKER, 'X' = SPEAKER NUMBER	WALL MOUNTED SPEAKER, 2 GANG RECESS MOUNT BACK BOX	5'
(S) <sub>X</sub>	CEILING SPEAKER , 'X' = SPEAKER NUMBER	CEILING MOUNTED SPEAKER	10'
PX	EXISTING AV CEILING MOUNTED PROJECTOR	EXISTING CEILING MOUNTED PROJECTOR	10'
(LVC) <sub>X</sub>	PROJECTION SCREEN INTEGRATED LVC, 'X' = SCREEN NUMBER	1 GANG JUNCTION BOX MOUNTED TO SIDE OF SCREEN HOUSING	5'
TP X	TABLE MOUNTED TOUCH PANEL, 'X' = TOUCH PANEL NUMBER	TABLETOP MOUNTED TOUCH PANEL	10'
<b>→</b> 2	2 PORT WALL MOUNTED DATA OUTLET	N/A	N/A
$\rightarrow$	120V, 20A, WALL MOUNTED DUPLEX POWER OUTLET	N/A	N/A
	120V, 20A, CEILING/CABLE TRAY MOUNTED DUPLEX POWER OUTLET	N/A	N/A



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IALR 150 SLAYTON AV DANVILLE, VA 24540

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□ No Resubmission Required
□ Rejected, Revise & Resubmit

Reviewed By:

Date:\_

1 01/08/2019 ISSUE FOR COORDINATION
0 10/25/2018 ISSUE FOR REVIEW
REV DATE DESCRIPTION

DATE: 10/25/2018 SCALE: 1/8" = 1'-0" DRAWN: B.HOAGE ENG BY: S.ODONNELL


SHEET SIZE ARCH D 36 X 24

GREAT HALL AUDIOVISUAL ELECTRICAL CEILING PLAN

DRAWING N

TA01-211

L06877

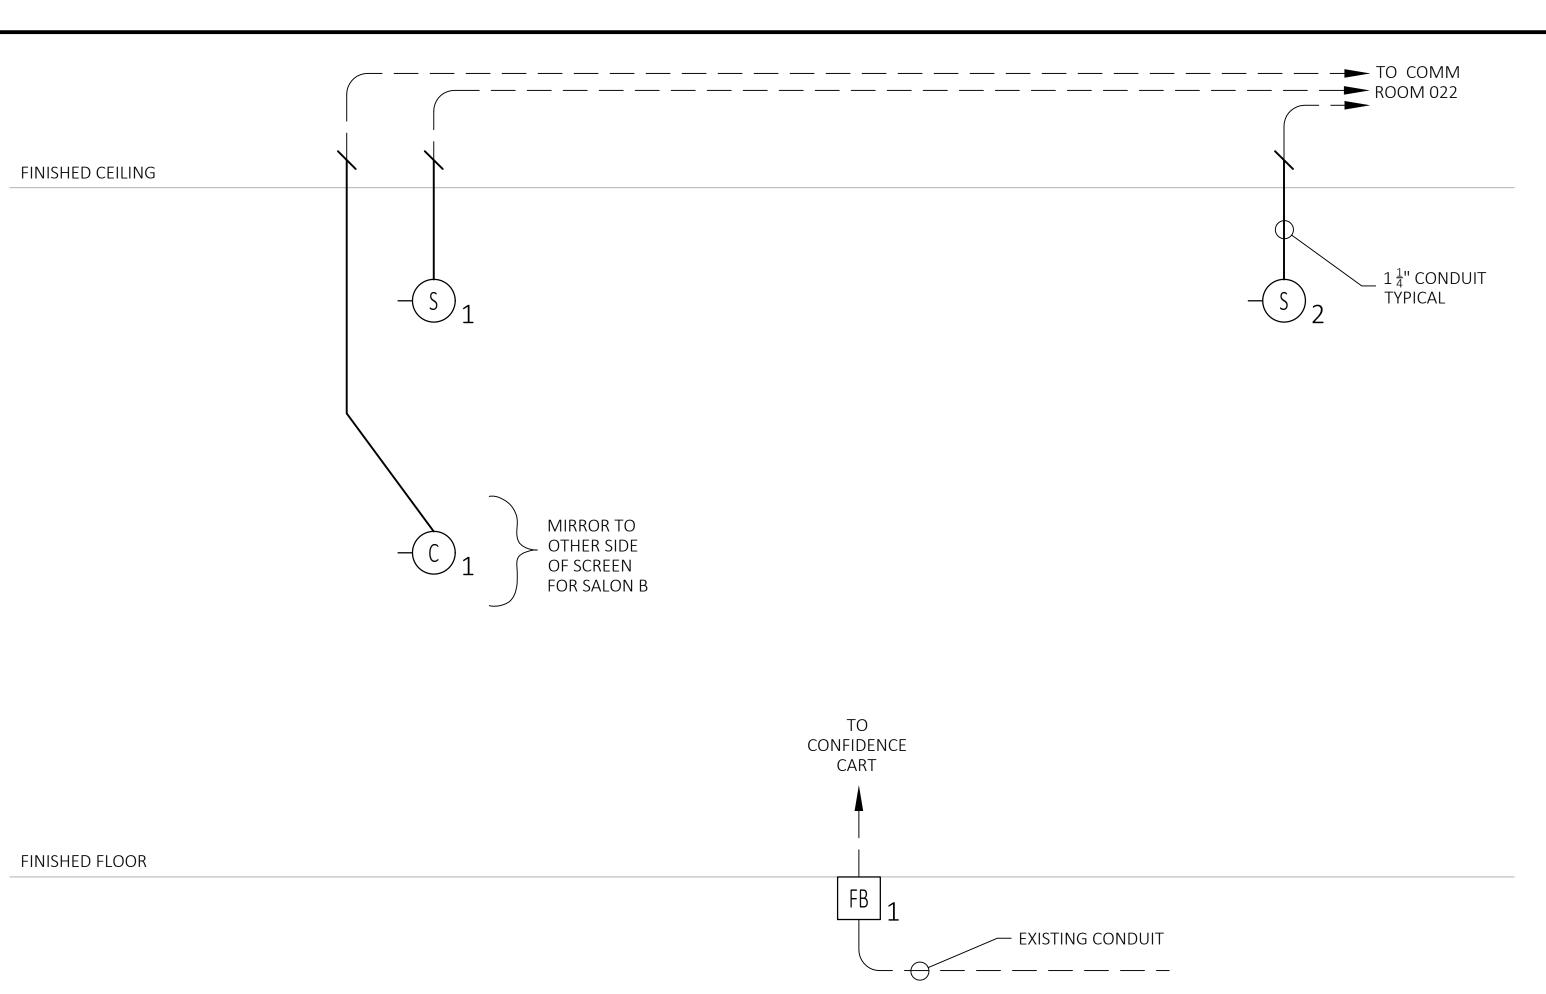

	AV JUNCTION BOX A		
SYMBOL	FUNCTION	DESCRIPTION	SLACK
-(AV2) <sub>X</sub>	AV WALL BOX, 'X' = BOX NUMBER	2 GANG RECESS MOUNTED BACK BOX	10'
-AVP1 <sub>X</sub>	AV WALL BOX, 'X' = BOX NUMBER	CHIEF PAC526 BACK BOX (PROVIDED BY AVC AND INSTALLED BY G.C.)	10'
-WP2) <sub>X</sub>	AV WALL CONNECTION PLATE, 'X' = PLATE NUMBER	2 GANG RECESS MOUNTED BACK BOX	10'
-WP4) <sub>X</sub>	AV WALL CONNECTION PLATE, 'X' = PLATE NUMBER	4 GANG RECESS MOUNTED BACK BOX	10'
-(KP2) <sub>X</sub>	AV CONTROL KEYPAD, 'X' = BOX NUMBER	CRESTRON TST-902-DSW-BB BACK BOX	10'
-ER6 <sub>X</sub>	EQUIPMENT RACK, 'X' = BOX NUMBER	12 X 12 NEMA JUNCTION BOX	20'
FBX	EXISTING FLOOR BOX	EXISTING FLOOR BOX	N/A
-(C) <sub>X</sub>	VTC CAMERA , 'X' = CAMERA NUMBER	WALL MOUNTED CAMERA, 2 GANG RECESS MOUNT BACK BOX	10'
© <sub>X</sub>	CEILING VTC CAMERA , 'X' = CAMERA NUMBER	CEILING MOUNTED CAMERA	10'
-(S) <sub>X</sub>	WALL MOUNTED SPEAKER , 'X' = SPEAKER NUMBER	WALL MOUNTED SPEAKER, 2 GANG RECESS MOUNT BACK BOX	5'
(S) <sub>X</sub>	CEILING SPEAKER , 'X' = SPEAKER NUMBER	CEILING MOUNTED SPEAKER	10'
PX	EXISTING AV CEILING MOUNTED PROJECTOR	EXISTING CEILING MOUNTED PROJECTOR	10'
(VC) <sub>X</sub>	PROJECTION SCREEN INTEGRATED LVC, 'X' = SCREEN NUMBER	1 GANG JUNCTION BOX MOUNTED TO SIDE OF SCREEN HOUSING	5'
TPX	TABLE MOUNTED TOUCH PANEL, 'X' = TOUCH PANEL NUMBER	TABLETOP MOUNTED TOUCH PANEL	10'
$\triangleleft$ 2	2 PORT WALL MOUNTED DATA OUTLET	N/A	N/A
$\Rightarrow$	120V, 20A, WALL MOUNTED DUPLEX POWER OUTLET	N/A	N/A
	120V, 20A, CEILING/CABLE TRAY MOUNTED DUPLEX POWER OUTLET	N/A	N/A



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IALR 150 SLAYTON AV DANVILLE, VA 24540

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Reviewed By:\_

Date:

			TO COMM ROOM 022
FINISHED CEILING			
	1 ½" CONDUIT TYPICAL	1 ½" CONDUIT TYPICAL	
-(c) <sub>2</sub>			
		(KP2) 1	
	$-(WP4)_{1}$ $1^{-(WP4)}_{2}$ 2	—(WP2) 1	

GREAT HALL - SALON C - SIDE WALL

GREAT HALL - SALON A & B - NORTH WALL

AUDIOVISUAL RISER DIAGRAM
SCALE: NTS GRE

1 01/08/2019 ISSUE FOR COORDINATION
0 10/25/2018 ISSUE FOR REVIEW

REV DATE DESCRIPTION

DATE: 10/25/2018 SCALE: NTS DRAWN: B.HOAGE ENG BY: S.ODONNELL

SHEET SIZE ARCH D 36 X 24


GREAT HALL
SALON A, B & C
AUDIOVISUAL
RISER
DIAGRAMS

DRAWING N

TA01-231

L06877

L06877 TA01-231 Great Hall - Salon A, B & C - Audiovisual Riser Diagrams.dwg

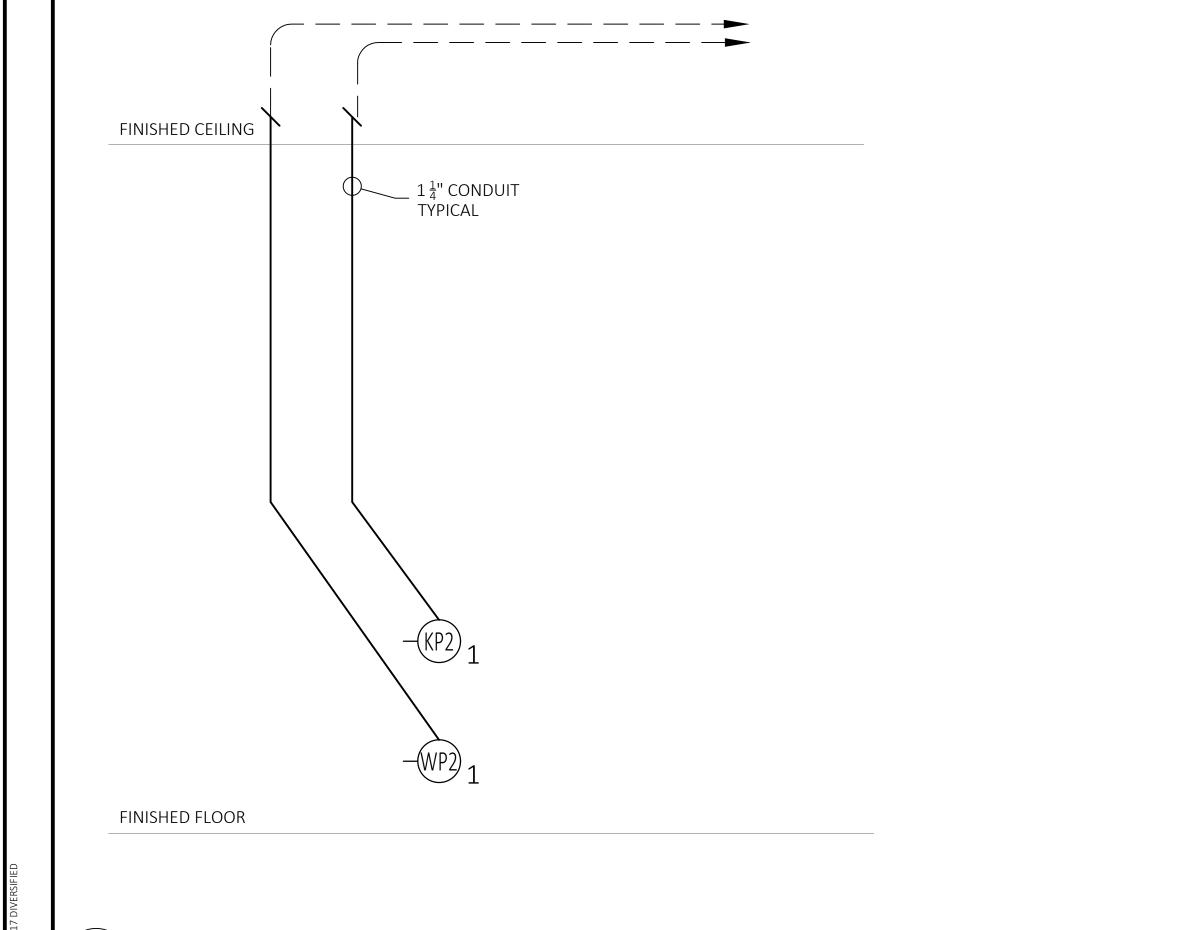


GREAT HALL - SALON A - SIDE WALL

AUDIOVISUAL RISER DIAGRAM

AUDIOVISUAL RISER DIAGRAM

SCALE: NTS

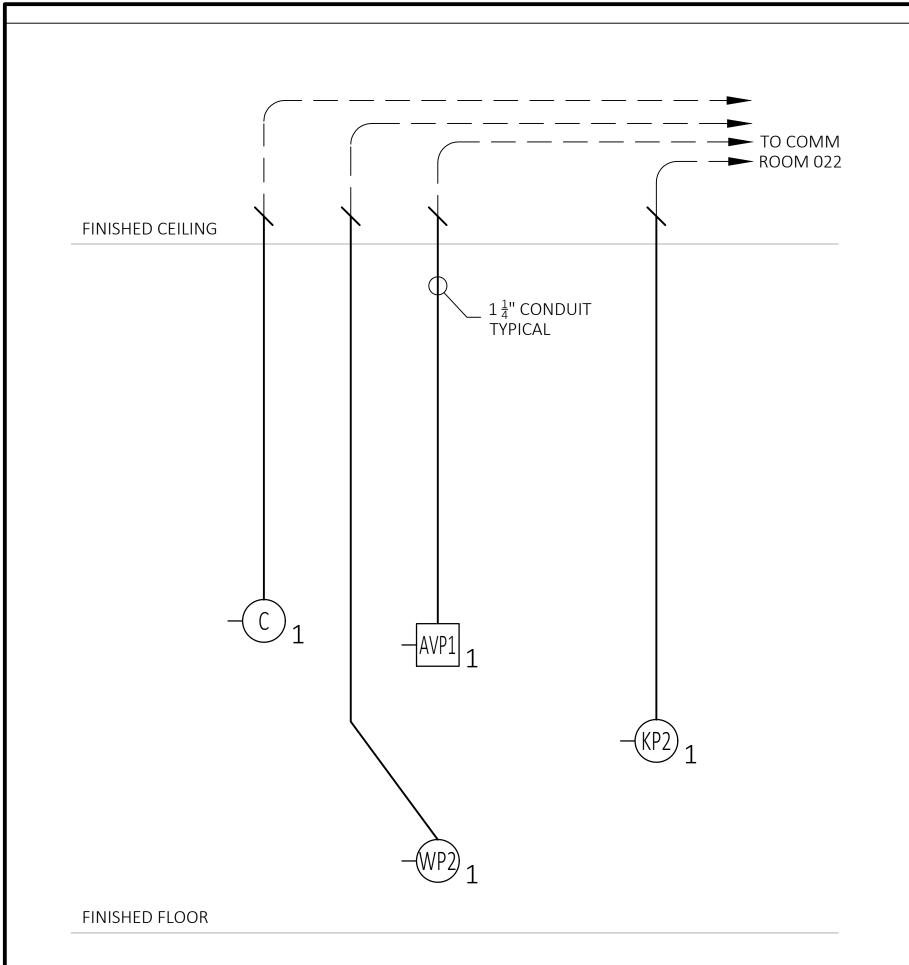

	AV JUNCTION BOX A	AND DEVICE SCHEDULE	_
SYMBOL	FUNCTION	DESCRIPTION	SLACK
-(AV2) <sub>X</sub>	AV WALL BOX, 'X' = BOX NUMBER	2 GANG RECESS MOUNTED BACK BOX	10'
-AVP1 X	AV WALL BOX, 'X' = BOX NUMBER	CHIEF PAC526 BACK BOX (PROVIDED BY AVC AND INSTALLED BY G.C.)	10'
-WP2) <sub>X</sub>	AV WALL CONNECTION PLATE, 'X' = PLATE NUMBER	2 GANG RECESS MOUNTED BACK BOX	10'
-WP4) X	AV WALL CONNECTION PLATE, 'X' = PLATE NUMBER	4 GANG RECESS MOUNTED BACK BOX	10'
-KP2) <sub>X</sub>	AV CONTROL KEYPAD, 'X' = BOX NUMBER	CRESTRON TST-902-DSW-BB BACK BOX	10'
-ER6 <sub>X</sub>	EQUIPMENT RACK, 'X' = BOX NUMBER	12 X 12 NEMA JUNCTION BOX	20'
FBX	EXISTING FLOOR BOX	EXISTING FLOOR BOX	N/A
-C)X	VTC CAMERA , 'X' = CAMERA NUMBER	WALL MOUNTED CAMERA, 2 GANG RECESS MOUNT BACK BOX	10'
©x	CEILING VTC CAMERA , 'X' = CAMERA NUMBER	CEILING MOUNTED CAMERA	10'
-(S) <sub>X</sub>	WALL MOUNTED SPEAKER , 'X' = SPEAKER NUMBER	WALL MOUNTED SPEAKER, 2 GANG RECESS MOUNT BACK BOX	5'
(S) <sub>X</sub>	CEILING SPEAKER , 'X' = SPEAKER NUMBER	CEILING MOUNTED SPEAKER	10'
PX	EXISTING AV CEILING MOUNTED PROJECTOR	EXISTING CEILING MOUNTED PROJECTOR	10'
(VO) <sub>X</sub>	PROJECTION SCREEN INTEGRATED LVC, 'X' = SCREEN NUMBER	1 GANG JUNCTION BOX MOUNTED TO SIDE OF SCREEN HOUSING	5'
TPX	TABLE MOUNTED TOUCH PANEL, 'X' = TOUCH PANEL NUMBER	TABLETOP MOUNTED TOUCH PANEL	10'
$\triangleleft$ 2	2 PORT WALL MOUNTED DATA OUTLET	N/A	N/A
$\ominus$	120V, 20A, WALL MOUNTED DUPLEX POWER OUTLET	N/A	N/A
	120V, 20A, CEILING/CABLE TRAY MOUNTED DUPLEX POWER OUTLET	N/A	N/A

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IALR 150 SLAYTON AV DANVILLE, VA 24540

The client has reviewed this drawing and asks that the following actions be taken:

□ Approved, No Exceptions Taken□ Make Corrections Noted.□ No Resubmission Required□ Rejected, Revise & Resubmit

Reviewed By:\_


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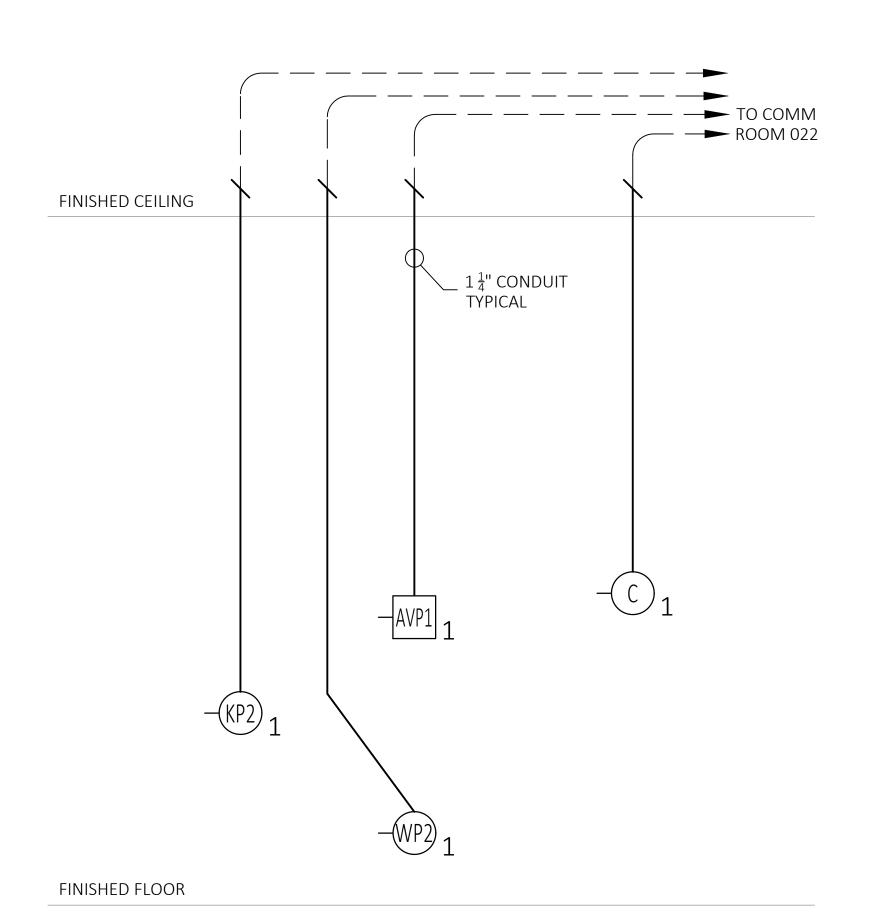
A AUDIOVISUAL SCALE: NTS


AUDIOVISUAL RISER DIAGRAM

AUDIOVISUAL RISER DIAGRAM

GREAT HALL - SALON E - SOUTH WALL



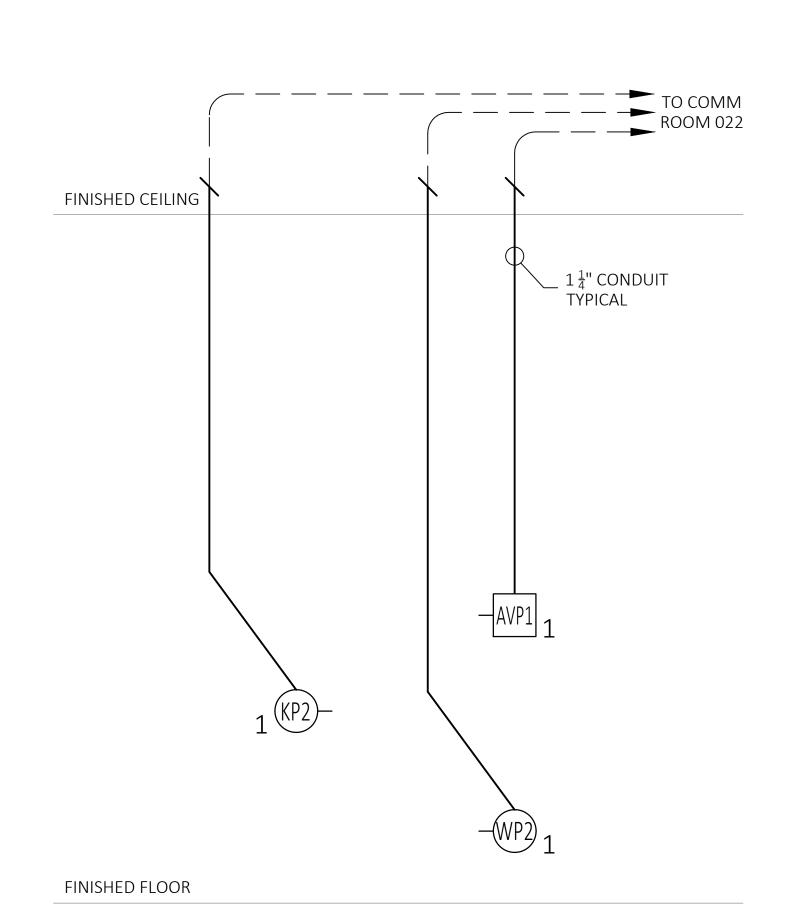

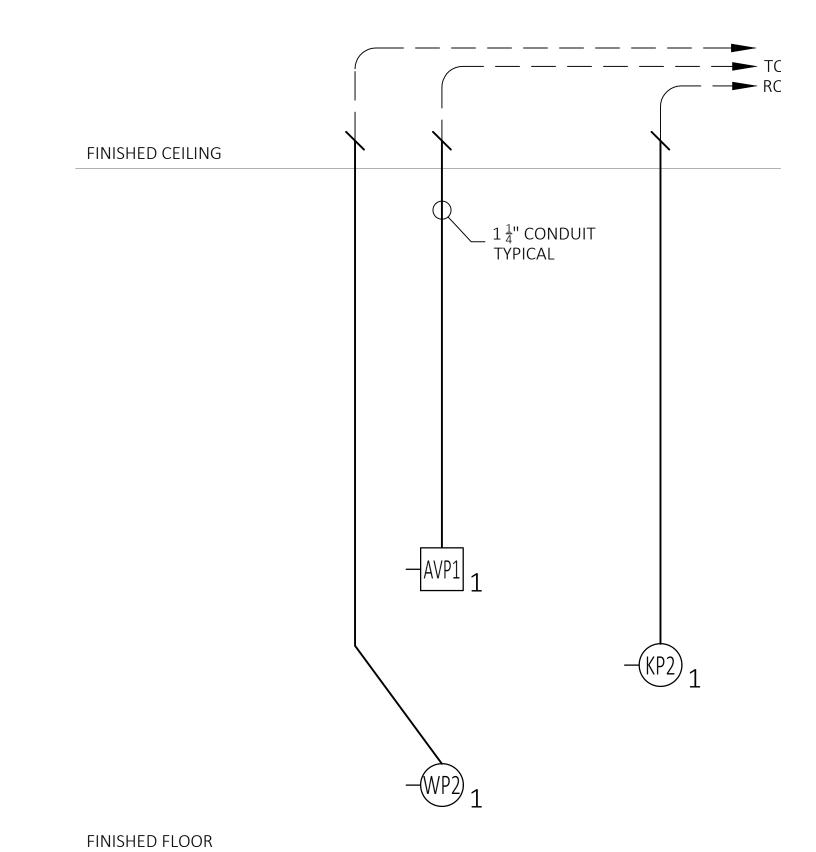

1 01/08/2019 ISSUE FOR COORDINATION
0 10/25/2018 ISSUE FOR REVIEW

REV DATE DESCRIPTION

DATE: 10/25/2018 SCALE: NTS DRAWN: B.HOAGE ENG BY: S.ODONNELL

SHEET SIZE ARCH D 36 X 24

GREAT HALL
SALON B, D, E & F
AUDIOVISUAL
RISER
DIAGRAMS

DRAWING NO.

TA01-232

PROJECT NO. L06877

AM GREAT HALL - SALON D - SOUTH WALL


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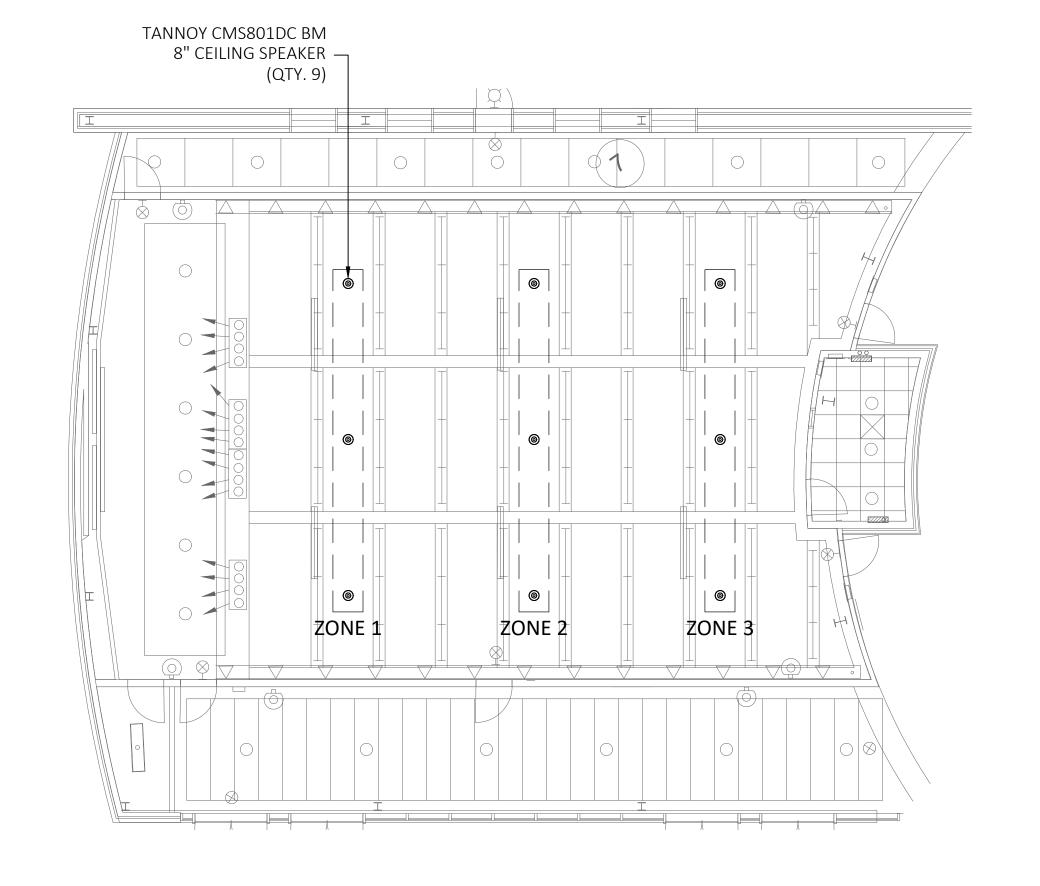
AUDIOVISUAL RISER DIAGRAM
SCALE: NTS GREAT HALL - SALON D - SIDE WALL

 $\left(\begin{array}{c} D \\ \overline{SC} \end{array}\right)$ 

D AUDIOVISUAL RISER DIAGRAM
SCALE: NTS GREAT HALL - SALON B - SIDE WALL

L06877 TA01-232 Great Hall - Salon B, D, E & F - Audiovisual Riser Diagrams.dwg



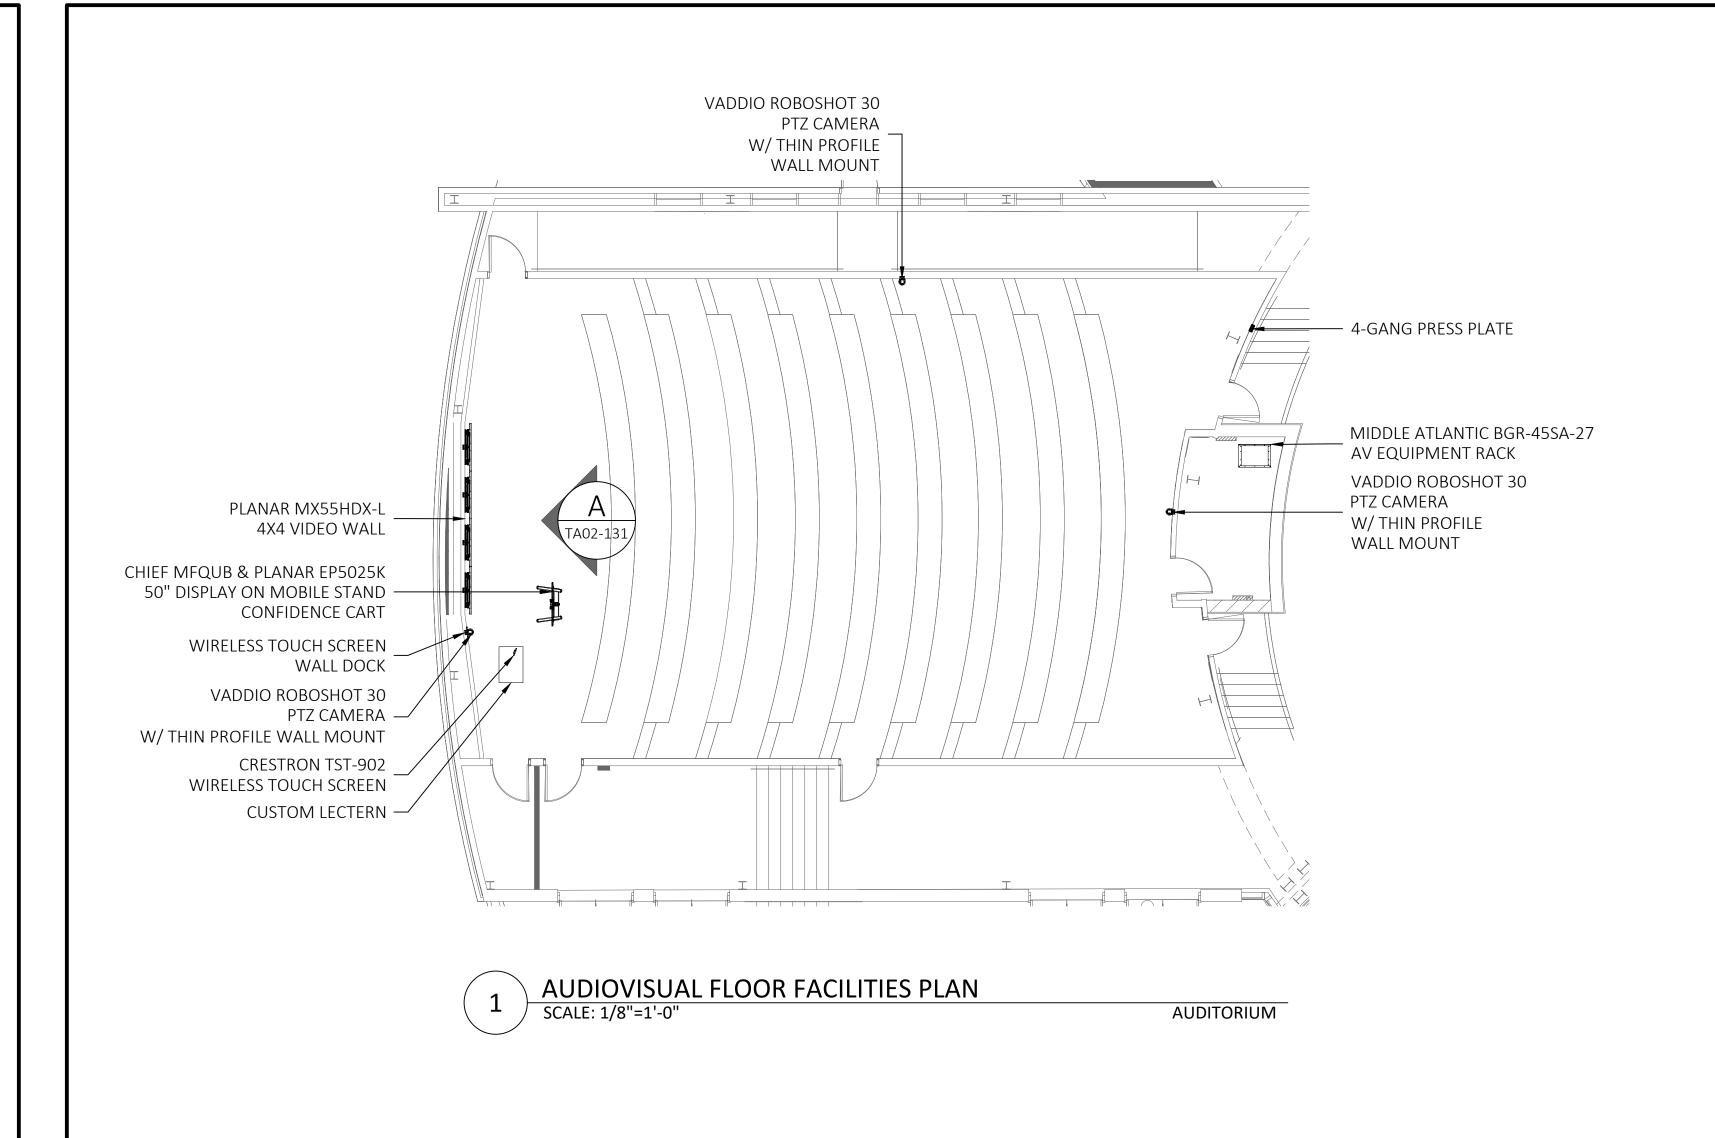

AUDIOVISUAL CIELING FACILITIES PLAN
SCALE: 1/8"=1'-0"



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IALR 150 SLAYTON AV DANVILLE, VA 24540

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Reviewed By:

AUDITORIUM

Date

1	01/08/2019	133UE FUR COURDINATION
0	10/25/2018	ISSUE FOR REVIEW
REV	DATE	DESCRIPTION

DATE: 10/25/2018 SCALE: 1/8" = 1'-0" DRAWN: B.HOAGE ENG BY: S.ODONNELL

SHEET SIZE ARCH D 36 X 24

AUDITORIUM AUDIOVISUAL FACILITIES PLANS


RAWING NO.

L06877

L06877

L06877 TA02-101 Auditorium - Audiovisual Facilities Plan.dwg




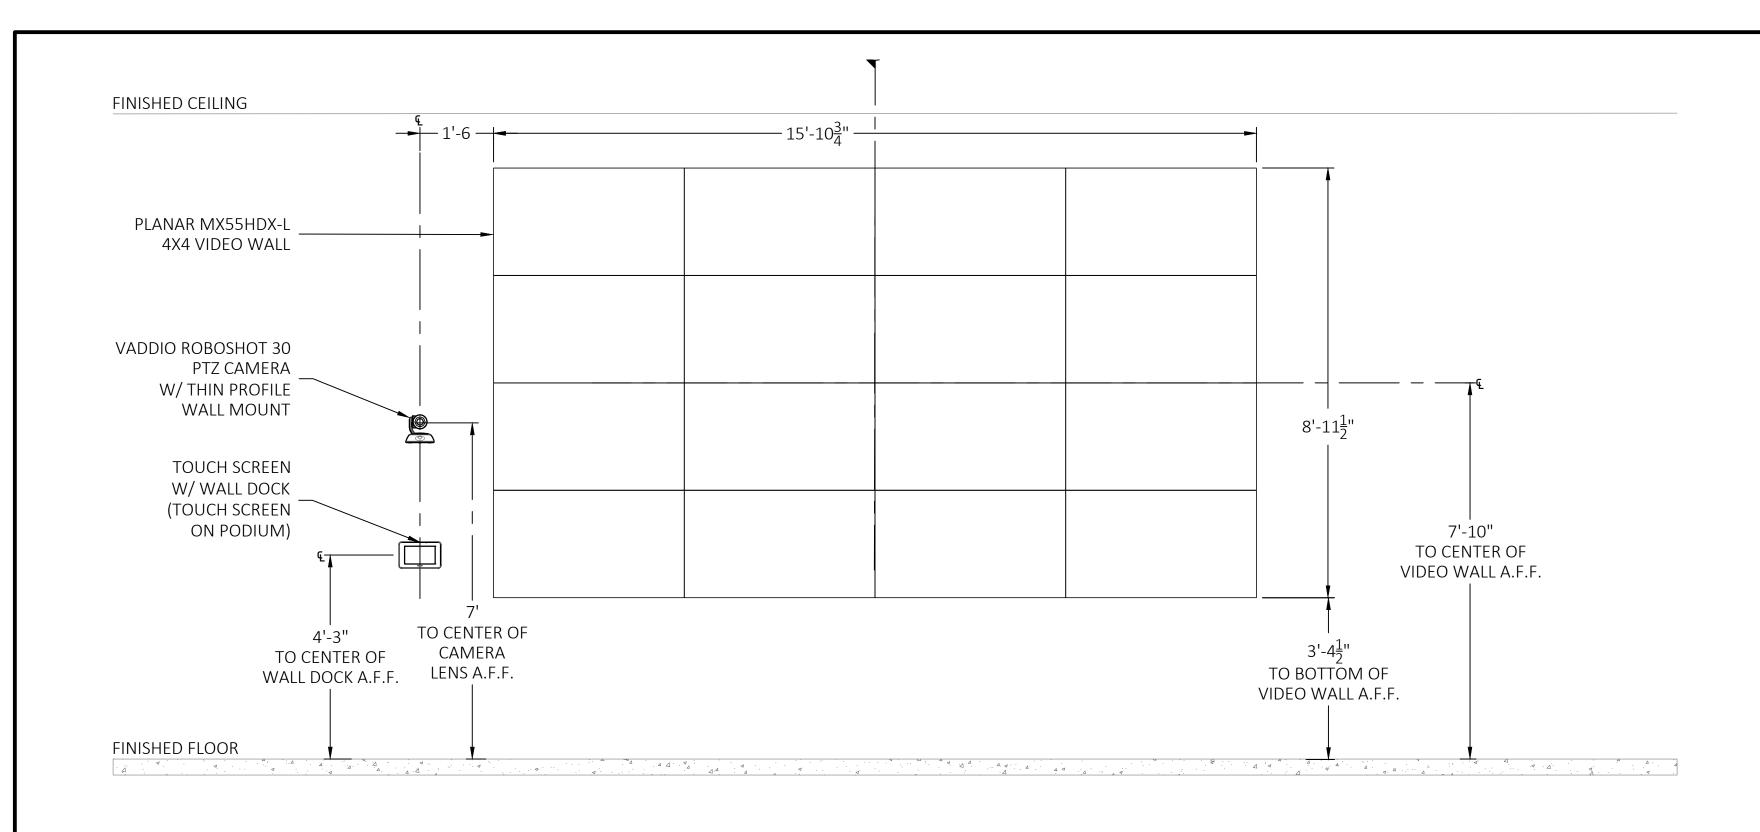


AUDIOVISUAL DISPLAY EQUIPMENT ELEVATION SCALE: 1/2"=1'-0"

SCALE: 1/2"=1'-0"

AUDITORIUM

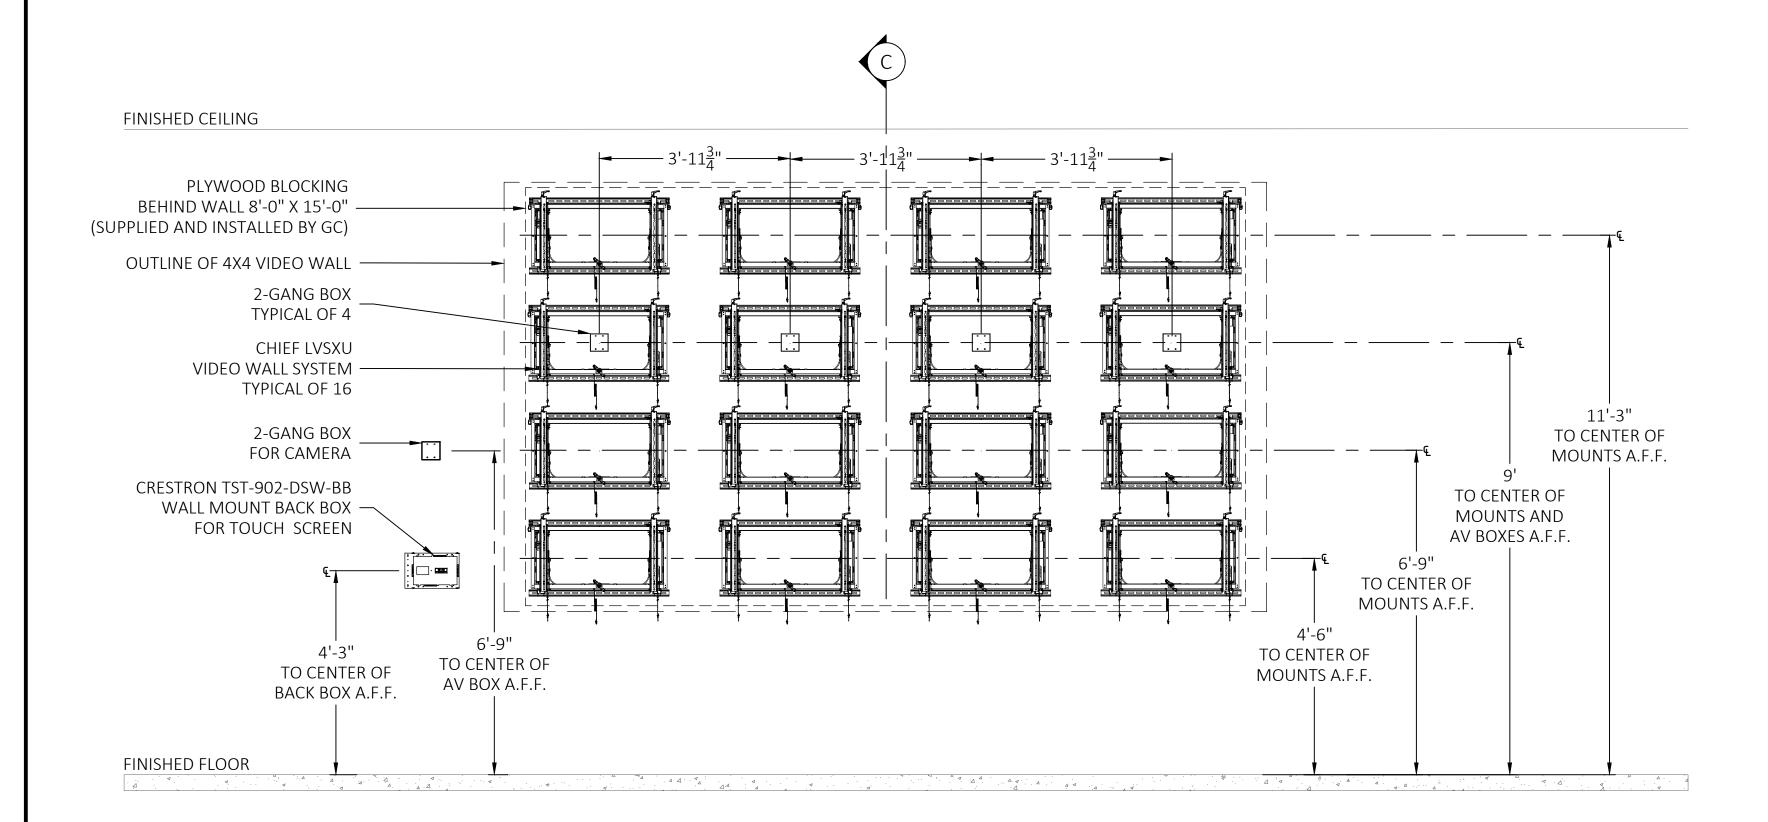

AUDIOVISUAL DISPLAY ELECTRICAL AND MOUNTING ELEVATION AUDITORIUM

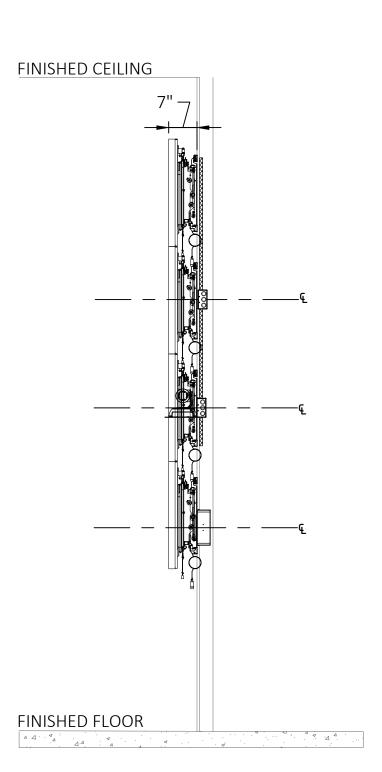

AUDIOVISUAL DISPLAY SECTION SCALE: 1/2"=1'-0"



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150 SLAYTON AV DANVILLE, VA 24540

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Reviewed By:

01/08/201 SUE FOR COORDINATION SUE FOR REVIEW DATE DESCRIPTION


> DATE: 10/25/2018 SCALE: 1/2" = 1'-0" DRAWN: B.HOAGE ENG BY: S.ODONNELL


ARCH D 36 X 24

AUDITORIUM **AUDIOVISUAL** VIDEO WALL **ELEVATIONS** 

TA02-131

L06877

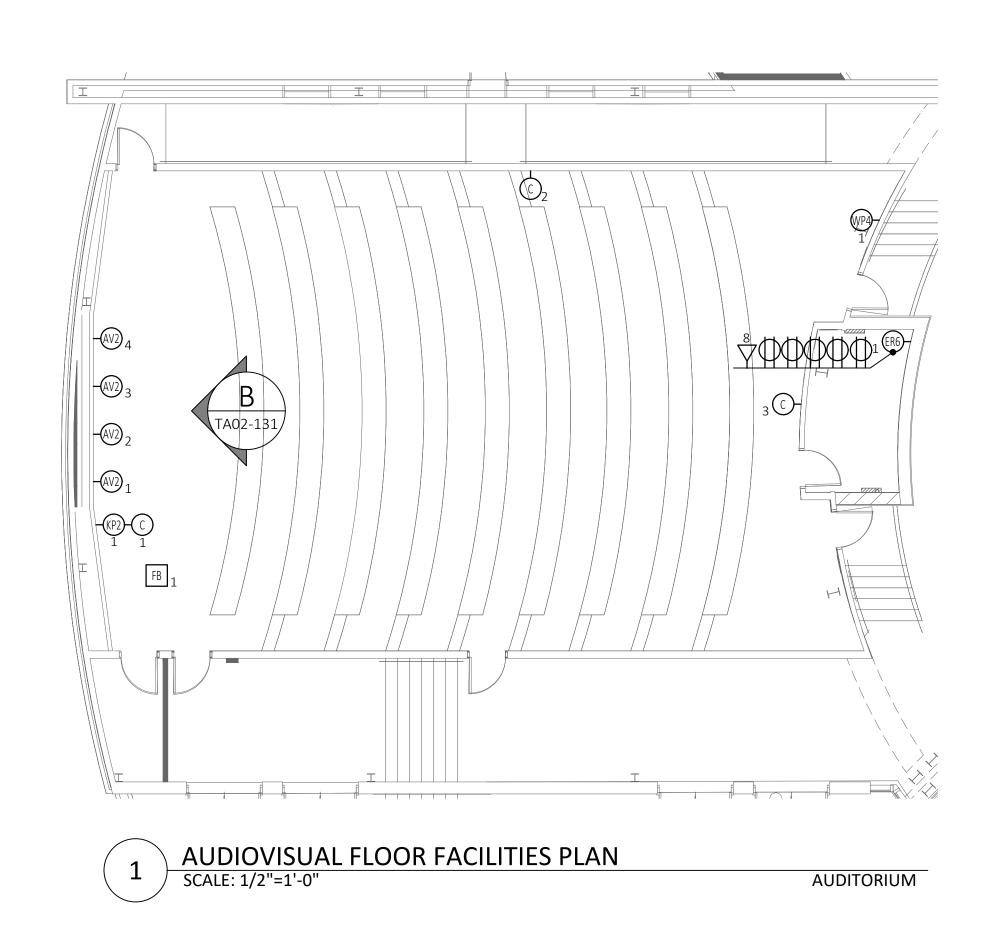

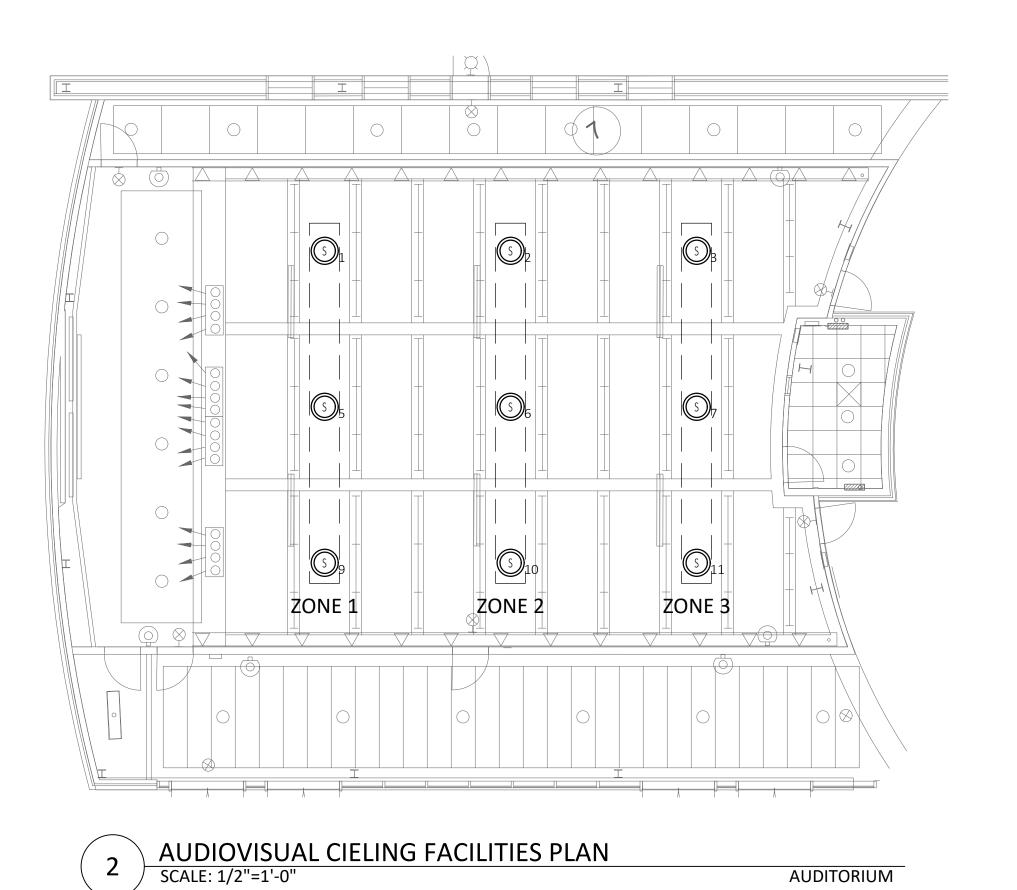

	AV JUNCTION BOX AND DEVICE SCHEDULE				
SYMBOL	FUNCTION	DESCRIPTION	SLACK		
-(AV2) <sub>X</sub>	AV WALL BOX, 'X' = BOX NUMBER	2 GANG RECESS MOUNTED BACK BOX	10'		
-AVP1 X	AV WALL BOX, 'X' = BOX NUMBER	CHIEF PAC526 BACK BOX (PROVIDED BY AVC AND INSTALLED BY G.C.)	10'		
-WP2) <sub>X</sub>	AV WALL CONNECTION PLATE, 'X' = PLATE NUMBER	2 GANG RECESS MOUNTED BACK BOX	10'		
-WP4) <sub>X</sub>	AV WALL CONNECTION PLATE, 'X' = PLATE NUMBER	4 GANG RECESS MOUNTED BACK BOX	10'		
-(KP2) <sub>X</sub>	AV CONTROL KEYPAD, 'X' = BOX NUMBER	CRESTRON TST-902-DSW-BB BACK BOX	10'		
-ER6 <sub>X</sub>	EQUIPMENT RACK, 'X' = BOX NUMBER	12 X 12 NEMA JUNCTION BOX	20'		
FB X	EXISTING FLOOR BOX	EXISTING FLOOR BOX	N/A		
-© <sub>X</sub>	VTC CAMERA , 'X' = CAMERA NUMBER	WALL MOUNTED CAMERA, 2 GANG RECESS MOUNT BACK BOX	10'		
© <sub>X</sub>	CEILING VTC CAMERA , 'X' = CAMERA NUMBER	CEILING MOUNTED CAMERA	10'		
-(S) <sub>X</sub>	WALL MOUNTED SPEAKER, 'X' = SPEAKER NUMBER	WALL MOUNTED SPEAKER, 2 GANG RECESS MOUNT BACK BOX	5'		
(S) <sub>X</sub>	CEILING SPEAKER , 'X' = SPEAKER NUMBER	CEILING MOUNTED SPEAKER	10'		
PX	EXISTING AV CEILING MOUNTED PROJECTOR	EXISTING CEILING MOUNTED PROJECTOR	10'		
(LVC) <sub>X</sub>	PROJECTION SCREEN INTEGRATED LVC, 'X' = SCREEN NUMBER	1 GANG JUNCTION BOX MOUNTED TO SIDE OF SCREEN HOUSING	5'		
TP X	TABLE MOUNTED TOUCH PANEL, 'X' = TOUCH PANEL NUMBER	TABLETOP MOUNTED TOUCH PANEL	10'		
<b>→</b> 2	2 PORT WALL MOUNTED DATA OUTLET	N/A	N/A		
$\Rightarrow$	120V, 20A, WALL MOUNTED DUPLEX POWER OUTLET	N/A	N/A		
	120V, 20A, CEILING/CABLE TRAY MOUNTED DUPLEX POWER OUTLET	N/A	N/A		



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150 SLAYTON AV DANVILLE, VA 24540

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Reviewed By:

Da

1 01/08/2019 ISSUE FOR COORDINATION
0 10/25/2018 ISSUE FOR REVIEW
REV DATE DESCRIPTION

DATE: 10/25/2018 SCALE: 1/8" = 1'-0" DRAWN: B.HOAGE ENG BY: S.ODONNELL

SHEET SIZE ARCH D 36 X 24


AUDITORIUM AUDIOVISUAL ELECTRICAL PLANS

DRAWING NO.

TA02-201

L06877

L06877 TA02-201 Auditorium - Audiovisual Electrical Plan.dwg

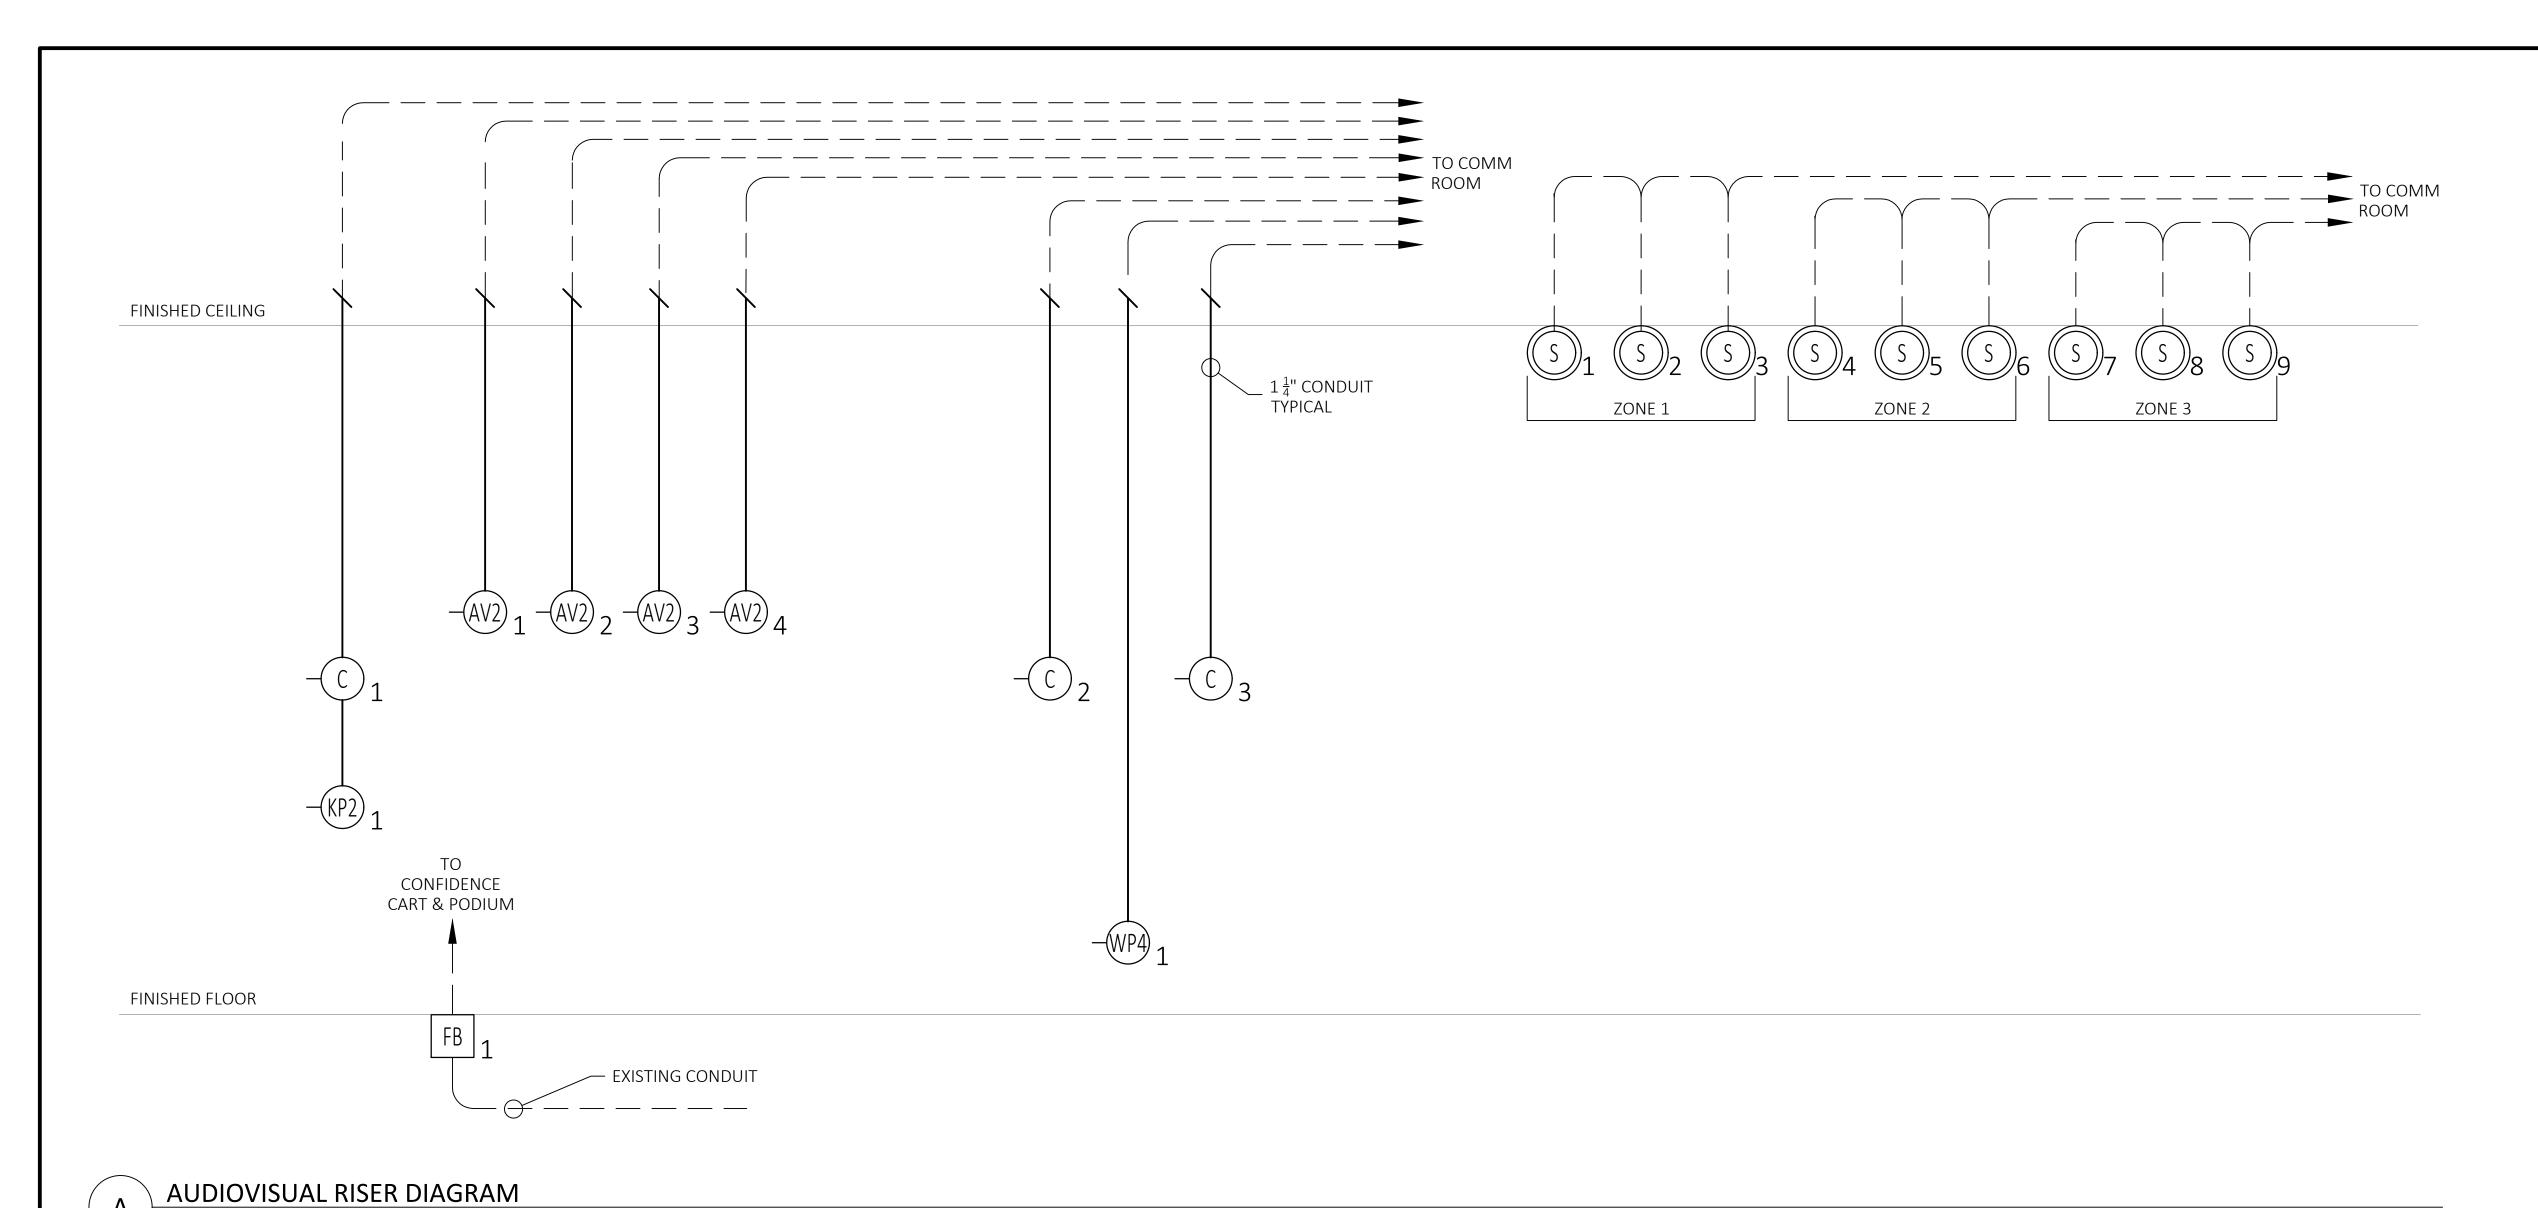

AV JUNCTION BOX AND DEVICE SCHEDULE FUNCTION DESCRIPTION SLACK SYMBOL AV WALL BOX, 'X' = BOX NUMBER 2 GANG RECESS MOUNTED BACK BOX CHIEF PAC526 BACK BOX (PROVIDED BY AVC AND INSTALLED BY G.C.) AV WALL BOX, 'X' = BOX NUMBER AV WALL CONNECTION PLATE, 'X' = PLATE NUMBER 2 GANG RECESS MOUNTED BACK BOX AV WALL CONNECTION PLATE, 'X' = PLATE NUMBER 4 GANG RECESS MOUNTED BACK BOX AV CONTROL KEYPAD, 'X' = BOX NUMBER 10' CRESTRON TST-902-DSW-BB BACK BOX EQUIPMENT RACK, 'X' = BOX NUMBER 12 X 12 NEMA JUNCTION BOX EXISTING FLOOR BOX EXISTING FLOOR BOX VTC CAMERA , 'X' = CAMERA NUMBER WALL MOUNTED CAMERA, 2 GANG RECESS MOUNT BACK BOX CEILING VTC CAMERA , 'X' = CAMERA NUMBER CEILING MOUNTED CAMERA WALL MOUNTED SPEAKER, 'X' = SPEAKER NUMBER WALL MOUNTED SPEAKER, 2 GANG RECESS MOUNT BACK BOX CEILING SPEAKER , 'X' = SPEAKER NUMBER CEILING MOUNTED SPEAKER EXISTING AV CEILING MOUNTED PROJECTOR EXISTING CEILING MOUNTED PROJECTOR PROJECTION SCREEN INTEGRATED LVC, 'X' = SCREEN NUMBER 1 GANG JUNCTION BOX MOUNTED TO SIDE OF SCREEN HOUSING TABLE MOUNTED TOUCH PANEL, 'X' = TOUCH PANEL NUMBER TABLETOP MOUNTED TOUCH PANEL 2 PORT WALL MOUNTED DATA OUTLET 120V, 20A, WALL MOUNTED DUPLEX POWER OUTLET 120V, 20A, CEILING/CABLE TRAY MOUNTED DUPLEX POWER OUTLET N/A N/A

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IALR 150 SLAYTON AV DANVILLE, VA 24540

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Reviewed By:\_

Date:

AUDITORIUM

0 10/25/2018 ISSUE FOR REVIEW
REV DATE DESCRIPTION

SSUE FOR COORDINATION

DATE: 10/25/2018 SCALE: NTS DRAWN: B.HOAGE ENG BY: S.ODONNELL

01/08/2019

SHEET SIZE ARCH D 36 X 24

AUDITORIUM AUDIOVISUAL RISER DIAGRAM


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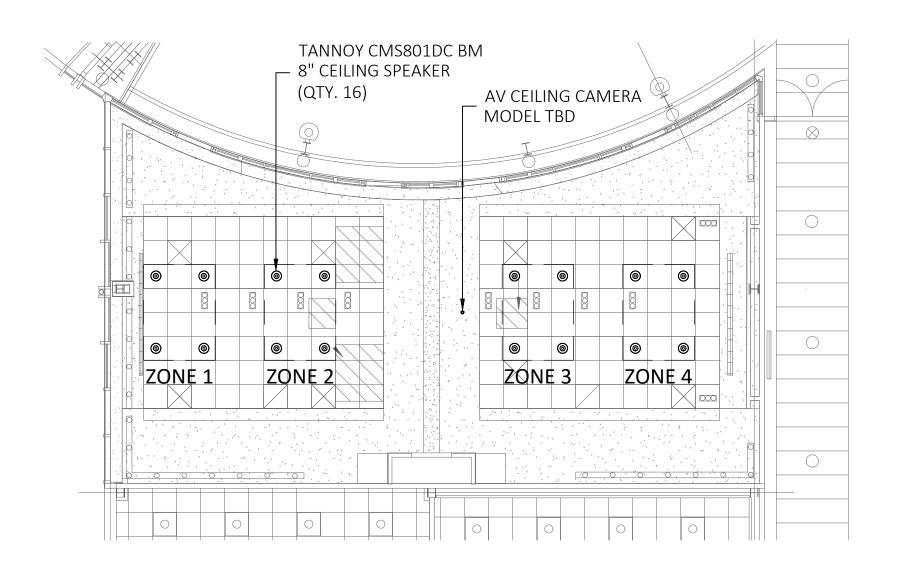
TA02-231

o. L06877

SCALE: NTS

L06877 TA02-231 Auditorium - Audiovisual Riser Diagrams.dwg



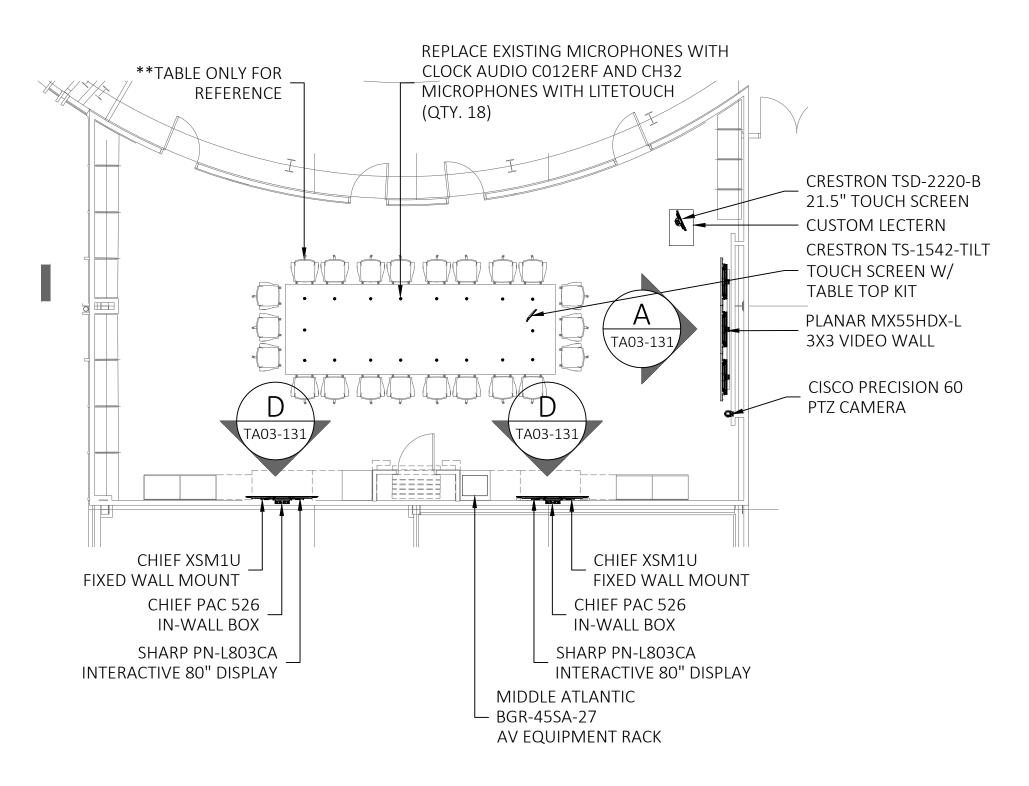

AUDIOVISUAL CIELING FACILITIES PLAN
SCALE: 1/8"=1'-0"

BOARDROOM

IVERSIFIED

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IALR 150 SLAYTON AV DANVILLE, VA 24540

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Reviewed By:

1 01/08/2019 SSUE FOR COORDINATION DATE DESCRIPTION

> DATE: 10/25/2018 SCALE: 1/8" = 1'-0" DRAWN: B.HOAGE ENG BY: S.ODONNELL

SHEET SIZE ARCH D 36 X 24


BOARDROOM AUDIOVISUAL **FACILITIES** PLANS

L06877

L06877

L06877 TA03-101 Boardroom - Audiovisual Facilities Plan.dwg



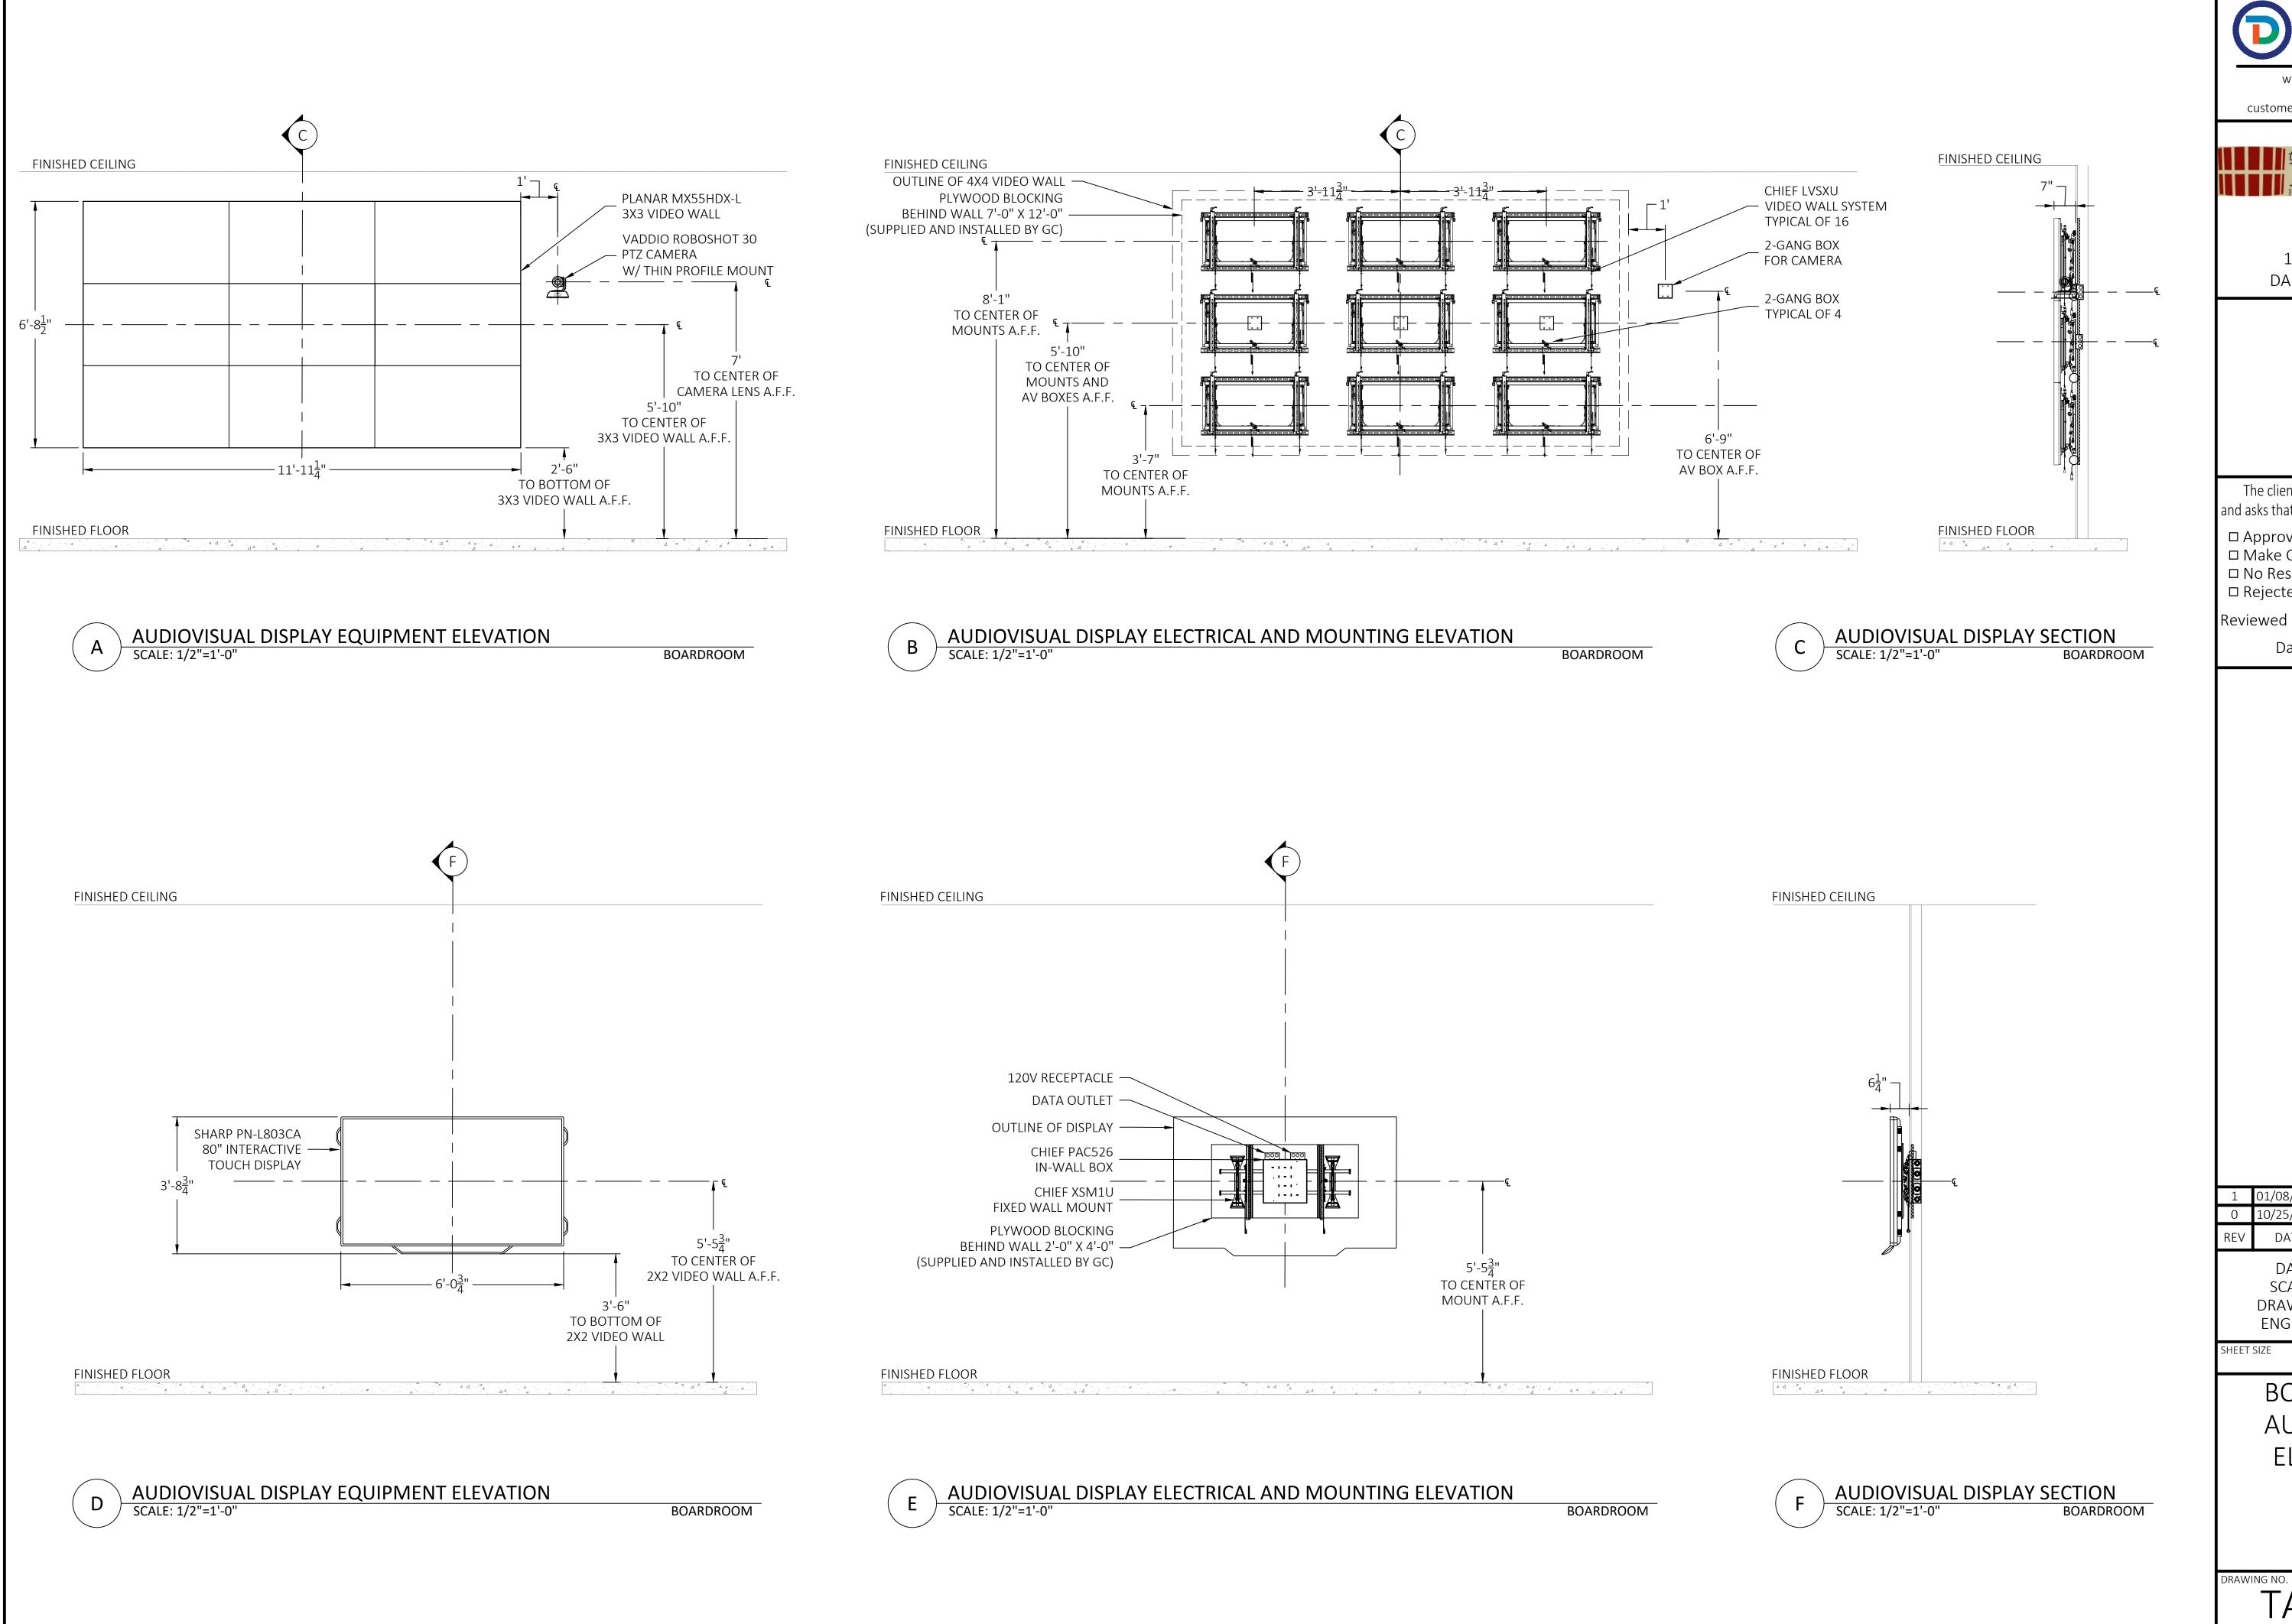

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IALR 150 SLAYTON AV DANVILLE, VA 24540

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Reviewed By:

01/08/201 SUE FOR COORDINATION SUE FOR REVIEW DATE DESCRIPTION


DATE: 10/25/2018 SCALE: 1/2" = 1'-0" DRAWN: B.HOAGE ENG BY: S.ODONNELL

ARCH D 36 X 24


BOARDROOM **AUDIOVISUAL ELEVATIONS** 

TA03-131

L06877

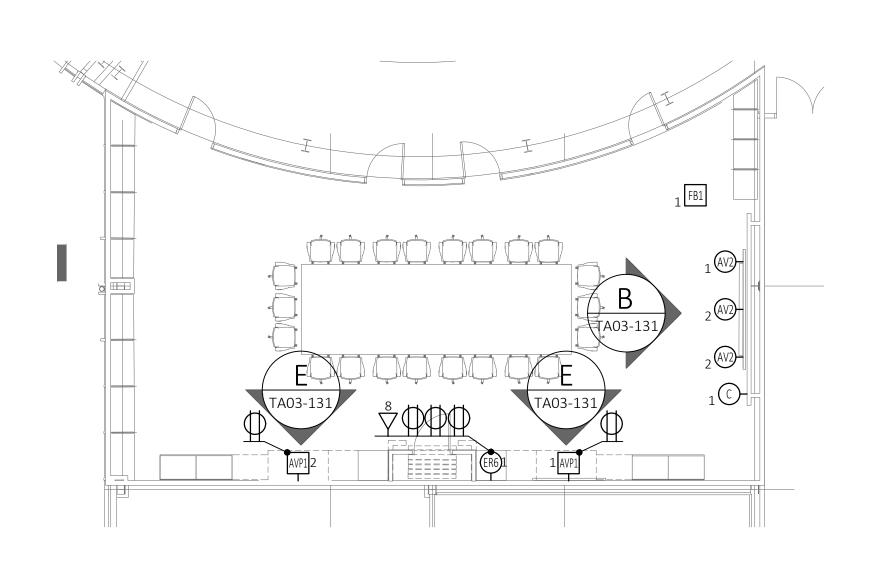

AUDIOVISUAL FLOOR ELECTRICAL PLAN
SCALE: 1/8"=1'-0"

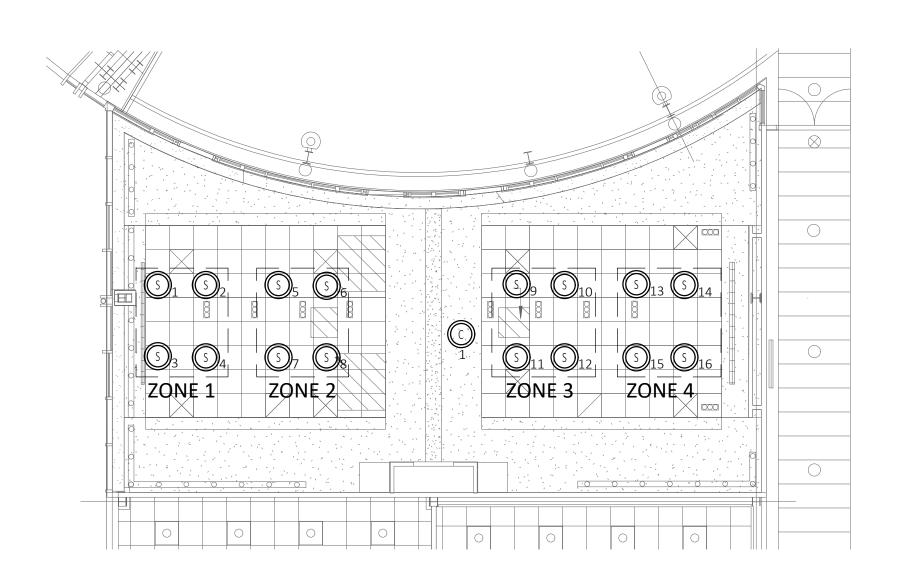

AUDIOVISUAL CIELING ELECTRICAL PLAN
SCALE: 1/8"=1'-0"

BOARDROOM

	AV JUNCTION BOX AND DEVICE SCHEDULE			
SYMBOL	FUNCTION	DESCRIPTION	SLACK	
-(AV2) <sub>X</sub>	AV WALL BOX, 'X' = BOX NUMBER	2 GANG RECESS MOUNTED BACK BOX	10'	
-AVP1 X	AV WALL BOX, 'X' = BOX NUMBER	CHIEF PAC526 BACK BOX (PROVIDED BY AVC AND INSTALLED BY G.C.)	10'	
-WP2 <sub>X</sub>	AV WALL CONNECTION PLATE, 'X' = PLATE NUMBER	2 GANG RECESS MOUNTED BACK BOX	10'	
-(WP4) X	AV WALL CONNECTION PLATE, 'X' = PLATE NUMBER	4 GANG RECESS MOUNTED BACK BOX	10'	
-(KP2) X	AV CONTROL KEYPAD, 'X' = BOX NUMBER	CRESTRON TST-902-DSW-BB BACK BOX	10'	
-ER6 <sub>X</sub>	EQUIPMENT RACK, 'X' = BOX NUMBER	12 X 12 NEMA JUNCTION BOX	20'	
FB X	EXISTING FLOOR BOX	EXISTING FLOOR BOX	N/A	
-© <sub>X</sub>	VTC CAMERA , 'X' = CAMERA NUMBER	WALL MOUNTED CAMERA, 2 GANG RECESS MOUNT BACK BOX	10'	
© <sub>X</sub>	CEILING VTC CAMERA , 'X' = CAMERA NUMBER	CEILING MOUNTED CAMERA	10'	
-(S) <sub>X</sub>	WALL MOUNTED SPEAKER, 'X' = SPEAKER NUMBER	WALL MOUNTED SPEAKER, 2 GANG RECESS MOUNT BACK BOX	5'	
(S) <sub>X</sub>	CEILING SPEAKER , 'X' = SPEAKER NUMBER	CEILING MOUNTED SPEAKER	10'	
PX	EXISTING AV CEILING MOUNTED PROJECTOR	EXISTING CEILING MOUNTED PROJECTOR	10'	
(LVC) <sub>X</sub>	PROJECTION SCREEN INTEGRATED LVC, 'X' = SCREEN NUMBER	1 GANG JUNCTION BOX MOUNTED TO SIDE OF SCREEN HOUSING	5'	

BOARDROOM



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150 SLAYTON AV DANVILLE, VA 24540

The client has reviewed this drawing and asks that the following actions be taken:

□ Approved, No Exceptions Taken □ Make Corrections Noted. □ No Resubmission Required
□ Rejected, Revise & Resubmit

Reviewed By:

1 01/08/2019 SSUE FOR COORDINATION

DATE DESCRIPTION

DATE: 10/25/2018 SCALE: 1/8" = 1'-0" DRAWN: B.HOAGE ENG BY: S.ODONNELL


SHEET SIZE ARCH D 36 X 24

BOARDROOM AUDIOVISUAL ELECTRICAL PLANS

TA03-201

L06877

L06877 TA03-201 Boardroom - Audiovisual Electrical Plan.dwg

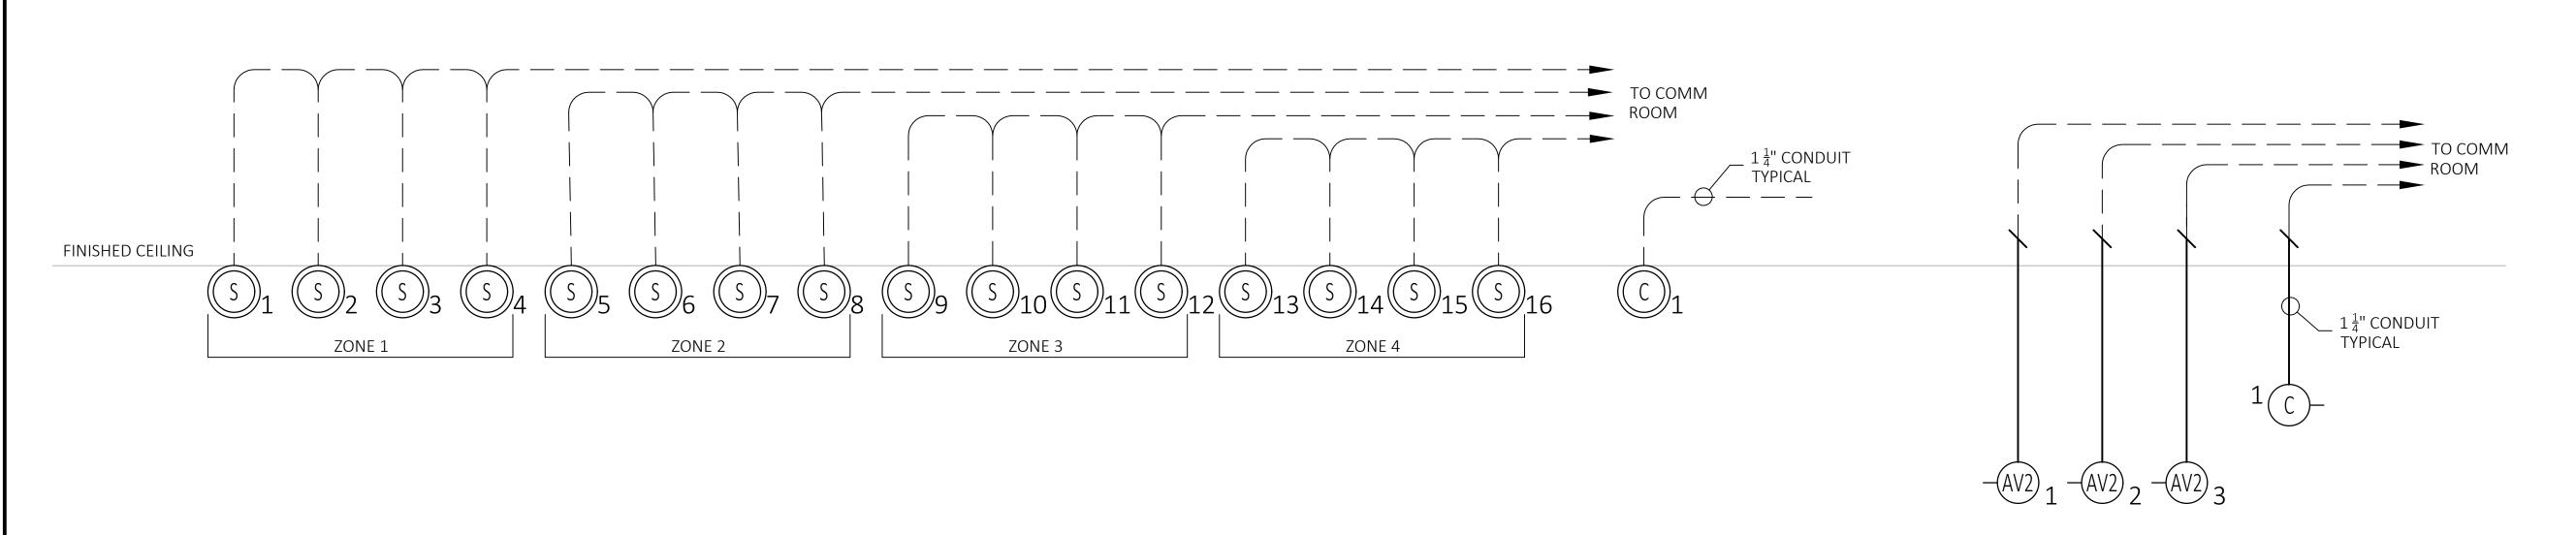

TO LECTERN

FB 1

EXISTING CONDUIT

FINISHED FLOOR

## A AUDIOVISUAL RISER DIAGRAM SCALE: NTS

EXECUTIVE BOARDROOM

	AV JUNCTION BOX A	AND DEVICE SCHEDULE	
SYMBOL	FUNCTION	DESCRIPTION	SLACK
-(AV2) <sub>X</sub>	AV WALL BOX, 'X' = BOX NUMBER	2 GANG RECESS MOUNTED BACK BOX	10'
-AVP1 <sub>X</sub>	AV WALL BOX, 'X' = BOX NUMBER	CHIEF PAC526 BACK BOX (PROVIDED BY AVC AND INSTALLED BY G.C.)	10'
-WP2 <sub>X</sub>	AV WALL CONNECTION PLATE, 'X' = PLATE NUMBER	2 GANG RECESS MOUNTED BACK BOX	10'
-WP4) <sub>X</sub>	AV WALL CONNECTION PLATE, 'X' = PLATE NUMBER	4 GANG RECESS MOUNTED BACK BOX	10'
-(KP2) <sub>X</sub>	AV CONTROL KEYPAD, 'X' = BOX NUMBER	CRESTRON TST-902-DSW-BB BACK BOX	10'
-ER6 X	EQUIPMENT RACK, 'X' = BOX NUMBER	12 X 12 NEMA JUNCTION BOX	20'
FBX	EXISTING FLOOR BOX	EXISTING FLOOR BOX	N/A
-C) <sub>X</sub>	VTC CAMERA , 'X' = CAMERA NUMBER	WALL MOUNTED CAMERA, 2 GANG RECESS MOUNT BACK BOX	10'
©x	CEILING VTC CAMERA , 'X' = CAMERA NUMBER	CEILING MOUNTED CAMERA	10'
-(5) <sub>X</sub>	WALL MOUNTED SPEAKER, 'X' = SPEAKER NUMBER	WALL MOUNTED SPEAKER, 2 GANG RECESS MOUNT BACK BOX	5'
(S) <sub>X</sub>	CEILING SPEAKER , 'X' = SPEAKER NUMBER	CEILING MOUNTED SPEAKER	10'
PX	EXISTING AV CEILING MOUNTED PROJECTOR	EXISTING CEILING MOUNTED PROJECTOR	10'
(LVC) <sub>X</sub>	PROJECTION SCREEN INTEGRATED LVC, 'X' = SCREEN NUMBER	1 GANG JUNCTION BOX MOUNTED TO SIDE OF SCREEN HOUSING	5'
ТРХ	TABLE MOUNTED TOUCH PANEL, 'X' = TOUCH PANEL NUMBER	TABLETOP MOUNTED TOUCH PANEL	10'
<b>→</b> 2	2 PORT WALL MOUNTED DATA OUTLET	N/A	N/A
$\Rightarrow$	120V, 20A, WALL MOUNTED DUPLEX POWER OUTLET	N/A	N/A
	120V, 20A, CEILING/CABLE TRAY MOUNTED DUPLEX POWER OUTLET	N/A	N/A

Diversified.

IMAGINATION ENGINEERED

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IALR 150 SLAYTON AV DANVILLE, VA 24540

The client has reviewed this drawing and asks that the following actions be taken:

□ Approved, No Exceptions Taken□ Make Corrections Noted.□ No Resubmission Required□ Rejected, Revise & Resubmit

Reviewed By:\_

Date

1 01/08/2019 ISSUE FOR COORDINATION
0 10/25/2018 ISSUE FOR REVIEW
REV DATE DESCRIPTION

DATE: 10/25/2018 SCALE: NTS DRAWN: B.HOAGE ENG BY: S.ODONNELL

SHEET SIZE ARCH D 36 X 24

EXECUTIVE
BOARDROOM
AUDIOVISUAL
RISER DIAGRAM

DRAWING NO.

TA03-231

L06877